# QUAIRADING SPORTS PRECINCT - NETBALL COURTS 10 JENNABERRING ROAD, QUAIRADING, WA.

### DRAWING SCHEDULE:

SE_12234_F000	COVER SHEET AND DRAWING SCHEDULE
SE_12234_F010	GENERAL NOTES
SE_12234_F100	SITE CLEARING LAYOUT PLAN
SE_12234_F200	GENERAL ARRANGEMENT AND PAVEMENT LAYOUT PLAN
SE_12234_F250	SITE SECTIONS
SE_12234_F300	STORMWATER DRAINAGE LAYOUT PLAN
SE_12234_F320	STORMWATER DRAINAGE DETAILS, PIT SCHEDULE AND LONG SECTIONS
SE_12234_F650	PAVEMENT PROFILES AND DETAILS
SE_12234_F700	1.05m HIGH FENCE DETAILS
SE_12234_F700	1.8m HIGH FENCE DETAILS



**REFERENCE INFORMATION** 

ITCW13057 F01 R0 FOR GIS1, REVISION A. DATED 24/09/2024, BY CARABINER.

LOCALITY PLAN - 10 JENNABERRING ROAD, QUAIRADING, WA, 6383.

### WARNING

BEWARE OF UNDERGROUND SERVICES

THE LOCATION OF UNDERGROUND SERVICES ARE APPROXIMATE ONLY. IT IS THE RESPONSIBILITY OF THE CONTRACTOR TO PROVE THEIR EXACT POSITION ON SITE. NO GUARANTEE IS GIVEN THAT ALL EXISTING SERVICES ARE SHOWN.

# NOT FOR CONSTRUCTION

PLOT DATE: 15/11/2024 PLOT TIME: 11:15 AM FILE PATH: C:\12dS\data\SPORTENG\12234 Quairading Sports Precinct - Netball Courts\_2770\03 Project Data\Drawings\Sheets\SE\_12234\_F000.dwg



OVERALL SITE LAYOUT PLAN ALL AERIAL IMAGERY USED IN THE PRODUCTION OF THIS DRAWING SET HAVE BEEN UNDER LICENSE FROM METROMAP.

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T1 15/11/24 RKC BWL ARM TENDER ISSUE Issue | Date | By | Chkd | Appd | Description

Job Title QUAIRADING SPORTS PRECINCT - NETBALL COURTS

Drawing Title COVER SHEET AND DRAWING SCHEDULE

Discipline
FIELD OF PLAY
Drawing Status TENDER
Drawing Number SE_12234_F000

T1

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Issue

### **GENERAL NOTES**

- 1. THESE DRAWINGS SHALL BE READ IN CONJUNCTION WITH THE TECHNICAL SPECIFICATIONS (SE\_12234\_SPC\_001\_A), ALL OTHER CONTRACT DOCUMENTS AND WITH OTHER WRITTEN INSTRUCTIONS AS MAY BE ISSUED BY THE PRINCIPAL'S REPRESENTATIVE DURING THE COURSE OF THE CONTRACT.
- 2. ALL LEVELS ARE EXPRESSED IN METRES TO AUSTRALIAN HEIGHT DATUM (AHD).
- 3. ALL COORDINATES ARE TO MAP GRID AUSTRALIA, UNIDENTIFIED LOCAL SYSTEM.
- 4. ALL DIMENSIONS ARE IN MILLIMETRES UNLESS NOTED OTHERWISE (U.N.O.). RADII ARE EXPRESSED IN METRES U.N.O.
- 5. ALL PLAN SET-OUT DIMENSIONS AND COORDINATES RELATE TO EDGE OF PAVEMENT OR KERB.
- 6. SPOT LEVELS RELATE TO FINISHED SURFACE LEVEL, U.N.O.
- 7. FINISHED SURFACE CONTOURS ARE SHOWN FOR INFORMATION ONLY AND ARE NOT TO BE USED FOR CONSTRUCTION SET-OUT PURPOSES. THE DRAWINGS ARE NOT TO BE SCALED.
- 8. CONSTRUCTION SET OUT INFORMATION WILL BE PROVIDED IN ELECTRONIC FORMAT (I.E. .DWG AND .12DA FILE CONTAINING 3D STRINGS AND TIN PRODUCED IN 12D MODEL). WORKS SHALL BE SET OUT BY A LICENCED SURVEYOR USING THE ELECTRONIC DATA PROVIDED.
- 9. ALL DIMENSIONS RELEVANT TO SETTING OUT SHALL BE CONFIRMED AND VERIFIED BY THE CONTRACTOR BEFORE CONSTRUCTION IS COMMENCED. THE CONTRACTOR SHALL REPORT ANY DISCREPANCIES TO THE PRINCIPAL'S REPRESENTATIVE.
- 10. ALL MATERIALS AND WORKMANSHIP SHALL BE IN ACCORDANCE WITH THE RELEVANT CURRENT AUSTRALIAN STANDARDS AND LOCAL AUTHORITY REQUIREMENTS EXCEPT WHERE VARIED BY THE DRAWINGS AND SPECIFICATION.

### FEATURE AND LEVEL SURVEY

- 11. THE LOCATION OF ALL EXISTING FEATURES SHOWN ON THE DRAWING HAVE BEEN REPRODUCED FROM SURVEY(S). AS VARIATIONS MAY EXIST, COMPLETE ACCURACY CANNOT BE GUARANTEED. THE DESIGN AND DOCUMENTATION IS BASED ON THE FOLLOWING SURVEY(S):
- FEATURE SURVEY TITLED ITCW13057 F01 R0 FOR GIS1, RECEIVED 06/09/2024, PROVIDED BY CARABINER AND QUAIRADING CITY COUNCIL.

### EXISTING SERVICES

- 12. THE LOCATIONS OF ALL EXISTING SERVICES SHOWN ON THE DRAWINGS HAVE BEEN REPRODUCED FROM SURVEY(S) AS LISTED ABOVE. AS VARIATIONS MAY EXIST COMPLETE ACCURACY CANNOT BE GUARANTEED. ALL EXISTING SERVICES LOCATIONS SHALL BE VERIFIED ON SITE BY THE CONTRACTOR BEFORE COMMENCING WORK.
- 13. PRIOR TO ANY DEMOLITION, EXCAVATION OR CONSTRUCTION ON THE SITE THE CONTRACTOR SHALL CONTACT THE RELEVANT AUTHORITIES TO ASCERTAIN THE POSSIBLE LOCATION OF FURTHER SERVICES AND DETAILED LOCATION AND DEPTH OF ALL SERVICES AND ARRANGE FOR THEIR RELOCATION WHERE NECESSARY.
- 14. ALL EXISTING AND PROPOSED SERVICES ARE TO BE PROTECTED DURING CONSTRUCTION U.N.O.
- 15. ALL SUB-SURFACE UTILITY INFORMATION IS QUALITY LEVEL D IN ACCORDANCE WITH AS5488.1 UNLESS SPECIFICALLY IDENTIFIED OTHERWISE.
- 16. WHERE KNOWN, THE CLASSIFICATION OF THE SUBSURFACE UTILITY DATA IS INDICATED IN ACCORDANCE WITH AS5488.1. E.G. "QL-B" OR "QUALITY LEVEL B", OR DRAWN WITHIN THE UTILITY LINESTYLE --- C(a) --- C(a) ---.
- 17. QUALITY LEVEL DESCRIPTION PER AS5488.1.
- (QL-A) = SURVEY OF EXPOSED AND VISIBLE ASSET +/- 50mm H +/- 50mm V.
- (QL-B) = SERVICE TRACING/SUB-SURFACE DETECTION +/- 300mm H +/- 500mm V.
- (QL-C) = SURFACE FEATURES AND DIRECT MEASUREMENT IN PITS/MANHOLES.
- (QL-D) = INDICATIVE LOCATION (EXISTING RECORDS/ANECDOTAL EVIDENCE).
- 18. EXISTING PIT COVERS, CHAMBERS, VALVE BOXES, AND GROUND-LEVEL SERVICE INFRASTRUCTURE ARE TO BE RAISED OR LOWERED TO SUIT THE PROPOSED FINISHED SURFACE LEVELS. THE CONTRACTOR IS TO ASSESS THE SUITABILITY OF THE EXISTING INFRASTRUCTURE FOR MODIFICATION AND ALLOW FOR REPLACEMENT AS NECESSARY.

### GEOTECHNICAL INVESTIGATION

- 19. PRIOR TO UNDERTAKING ANY EXCAVATION WORKS ON SITE, THE CONTRACTOR IS TO REVIEW THE SITE GEOTECHNICAL REPORT(S) TO UNDERSTAND THE COMPOSITION OF EXISTING MATERIAL, ASSOCIATED CONSTRUCTION RISK, AND RECOMMENDED METHODOLOGY. THE FOLLOWING GEOTECHNICAL REPORT(S) ARE AVAILABLE:
- GEOTECHNICAL INVESTIGATION NETBALL COURTS & LIGHT POLES, QUAIRADING SPORTS PRECINCT (GI297824PG\_REV0), REV0, DATED 30/09/2024, BY PERTH GEOTECHNICS BULK EARTHWORKS
- 20. ALL EXCAVATION INCLUDING CONSTRUCTION OF TEMPORARY CONSTRUCTION BATTERS SHALL COMPLY WITH THE RECOMMENDATIONS IN THE GEOTECHNICAL REPORT.
- 21. THE CONTRACTOR IS REQUIRED TO PREVENT SILT OR ANY TRANSPORTABLE SOLIDS FROM THE SITE ENTERING THE LOCAL DRAINAGE NETWORK, INCLUDING NEARBY WATERWAYS, BY MEANS OF TEMPORARY SILT INTERCEPTION PITS AND SCREENS.
- 22. THE CONTRACTOR SHALL ENSURE THAT ALL WORK SITES ARE MAINTAINED IN A SAFE AND STABLE CONDITION AND THAT ALL PARTS ARE WELL DRAINED AT ALL TIMES. DURING CONSTRUCTION THE CONTRACTOR SHALL BE RESPONSIBLE FOR MAINTAINING A TEMPORARY SITE DRAINAGE SYSTEM TO THE APPROVAL OF THE PRINCIPAL'S REPRESENTATIVE.
- 23. SUPERVISION AND TESTING OF BULK EARTHWORKS SHALL BE IN ACCORDANCE WITH SECTION 600 OF THE TECHNICAL SPECIFICATION. 24. BULK EARTHWORKS, BUILDING, AND FIELD OF PLAY WORKS AREAS SHALL BE CLEARED AND STRIPPED OF TOPSOIL/ORGANIC MATERIAL IN ACCORDANCE WITH SECTION 600 OF THE TECHNICAL SPECIFICATION.
- 25. MATERIALS AND PLACEMENT OF MATERIALS SHALL BE IN ACCORDANCE WITH SECTION 600 OF THE TECHNICAL SPECIFICATION.
- 26. SUBGRADE PREPARATION SHALL BE IN ACCORDANCE WITH SECTION 600 OF THE TECHNICAL SPECIFICATION.
- 27. BAD GROUND (E.G. SOFT, WET, UNSUITABLE MATERIAL, ETC.) SHALL BE REMOVED AND REPLACED OR TREATED IN-SITU IN ACCORDANCE WITH SECTION 600 OF THE TECHNICAL SPECIFICATION.
- 28. SURFACES UPON WHICH FILL IS TO BE PLACED, PLACED FILL LAYERS, AND SUBGRADES SHALL BE COMPACTED, MOISTURE CONDITIONED, AND PROOF ROLLED IN ACCORDANCE WITH SECTION 600 OF THE TECHNICAL SPECIFICATION.
- 29. ALL EARTHWORKS SURFACES SHALL BE VERIFIED BY SURVEY IN ACCORDANCE WITH SECTION 600 OF THE TECHNICAL SPECIFICATION.

### PAVEMENTS GENERAL

- 30. PAVEMENT TYPES VARY THROUGHOUT THE SITE. REFER TO PAVEMENT LAYOUT PLAN FOR EXTENTS OF EACH PAVEMENT TYPE.
- 31. ALL UNDERGROUND SERVICES ARE TO BE LAID PRIOR TO FINAL SEALING OF PAVEMENTS.

PLOT DATE: 15/11/2024 PLOT TIME: 11:15 AM FILE PATH: C:\12dS\data\SPORTENG\12234 Quairading Sports Precinct - Netball Courts\_2770\03 Project Data\Drawings\Sheets\SE\_12234\_F010.dwg

- 32. KERB PROFILES TO BE IN ACCORDANCE WITH THE STANDARD DRAWINGS OF THE LOCAL COUNCIL, U.N.O.
- 33. ASPHALT BINDER TO BE CLASS 320 U.N.O.



## NOT FOR CONSTRUCTION

### CONCRETE PAVEMENTS

- 34. REINFORCED CONCRETE PAVEMENTS TO BE CONSTRUCTED WITH JOINTS TO THE FOLLOWING TYPICAL SPACING U.N.O. CONCRETE PAVEMENT THICKNESS LESS THAN 150mm:
- SAW-CUT (CONTRACTION JOINT): 2 METRES
- EXPANSION JOINT (DOWELLED): 12 METRES

CONCRETE PAVEMENT THICKNESS 150mm OR GREATER:

- SAW-CUT (CONTRACTION JOINT): 4 METRES
- EXPANSION JOINT (DOWELLED): 16 METRES
- 35. ISOLATION JOINTS TO BE INSTALLED AT ALL INTERFACES ABUTTING STRUCTURES.
- 36. ALL PAVEMENT SLABS TO HAVE CONTINUOUS PERIMETER REINFORCING BAR IN LINE WITH PERIMETER OF REINFORCING MESH.
- 38. DOWELS TO BE INSTALLED BETWEEN CONCRETE FOOTPATH AND FIELD EDGE STRIP AT ALL GATE ENTRANCES.

### CONCRETE AND REINFORCEMENT

- 39. ALL WORKMANSHIP AND MATERIALS SHALL BE IN ACCORDANCE WITH SECTION 1500 OF THE TECHNICAL SPECIFICATION.
- 40. REINFORCEMENT IS REPRESENTED DIAGRAMMATICALLY AND NOT NECESSARILY SHOWN IN TRUE PROJECTION.
- 41. ALL FABRIC LAPS SHALL BE FULL STRENGTH TO CURRENT AUSTRALIAN STANDARDS.
- 42. WELDING OF REINFORCEMENT IS NOT PERMITTED WITHOUT THE APPROVAL OF THE PRINCIPAL'S REPRESENTATIVE. 43. ALL REINFORCEMENT SHALL BE SECURELY SUPPORTED IN ITS CORRECT POSITION DURING CONCRETING BY APPROVED BAR-CHAIR, SPACERS OR SUPPORT BARS. FORMWORK SHALL BE DESIGNED AND CONSTRUCTED IN ACCORDANCE WITH THE SPECIFICATION.
- 44. CONCRETE STRENGTH SHALL BE IN ACCORDANCE WITH THE SPECIFICATION.
- 45. DETAILS OF CONCRETE MIX, AGGREGATE SIZE AND COLOUR, METHOD OF CURING AND FINISH ARE TO BE SUBMITTED FOR APPROVAL

### STORMWATER DRAINAGE

- 46. PRIOR TO CONSTRUCTION, CONTRACTOR SHALL VERIFY INVERT LEVEL AND SIZE OF EXISTING DRAINAGE INFRASTRUCTURE AT ALL POINTS OF CONNECTION WITH PROPOSED DRAINAGE. REPORT DISCREPANCIES TO THE PRINCIPAL'S REPRESENTATIVE AND HOLD RELATED WORKS UNTIL FURTHER INSTRUCTION.
- 47. PRIOR TO CONSTRUCTION, CONTRACTOR SHALL ASSESS ALL PROPOSED DRAINAGE CROSSINGS WITH EXISTING UNDERGROUND SERVICES. REPORT DISCREPANCIES TO THE PRINCIPAL'S REPRESENTATIVE AND HOLD RELATED WORKS UNTIL FURTHER INSTRUCTION.
- 48. STORMWATER DRAINAGE TO BE CONSTRUCTED IN ACCORDANCE WITH SECTIONS 900 AND 910 OF THE TECHNICAL SPECIFICATION.
- 49. COVERS, FRAMES AND GRATES SHALL BE MINIMUM CLASS B IN NON-TRAFFICABLE AREAS OR CLASS D IN TRAFFICABLE AREAS, U.N.O.
- 50. PIPES SHALL BE RCP CLASS 2, PP (SN8), OR PVC-U (SN8) U.N.O.
- 51. PIPES Ø225mm AND GREATER TO BE CONSTRUCTED WITH MIN. 600mm COVER AND 1 IN 200 MIN. GRADE U.N.O.
- 52. PIPES Ø150mm AND SMALLER TO BE CONSTRUCTED WITH MIN. 600mm COVER AND 1 IN 100 MIN. GRADE U.N.O.
- 53. ALL DRAINAGE SHALL BE ADEQUATELY PROTECTED FROM CONSTRUCTION TRAFFIC.
- 54. EXISTING PIT FRAMES, COVERS AND GRATES TO BE MODIFIED TO SUIT THE PROPOSED FINISHED SURFACE LEVELS AND GRADES. THE CONTRACTOR IS TO ASSESS THE SUITABILITY OF EXISTING STRUCTURES FOR RE-USE AND ALLOW FOR REPLACEMENT AS NECESSARY.
- 57. ALL EXISTING REMAINING DRAINAGE SHALL BE CHECKED FOR LEVEL, SIZE, AND LOCATION AND CONNECTED TO THE NEW DRAINAGE SYSTEM.

37. TRIMMER BARS (1.0m LONG, N12 DEFORMED BAR) TO BE PLACED AT ALL RE-ENTRANT CORNERS AND AT ALL CORNERS OF PENETRATIONS GREATER THAN 300mm.


55. ALL EXISTING PITS WITHIN EXTENT OF WORKS SHALL HAVE THEIR COVERS OR GRATES ASSESSED FOR LOAD ADEQUACY AND CONDITION AND REPLACED WHERE REQUIRED 56. ALL EXISTING PITS REQUIRING ADJUSTMENT OR CONNECTION SHALL BE BENCHED WITH CONCRETE TO SMOOTHLY TRANSITION BETWEEN INLET(S) AND OUTLET(S).

> Job Title QUAIRADING SPORTS PRECINCT - NETBALL COURTS


Drawing Title GENERAL NOTES


Discipline
FIELD OF PLAY
Drawing Status
TENDER
Drawing Number
SE 12234 F010

Issue |T1

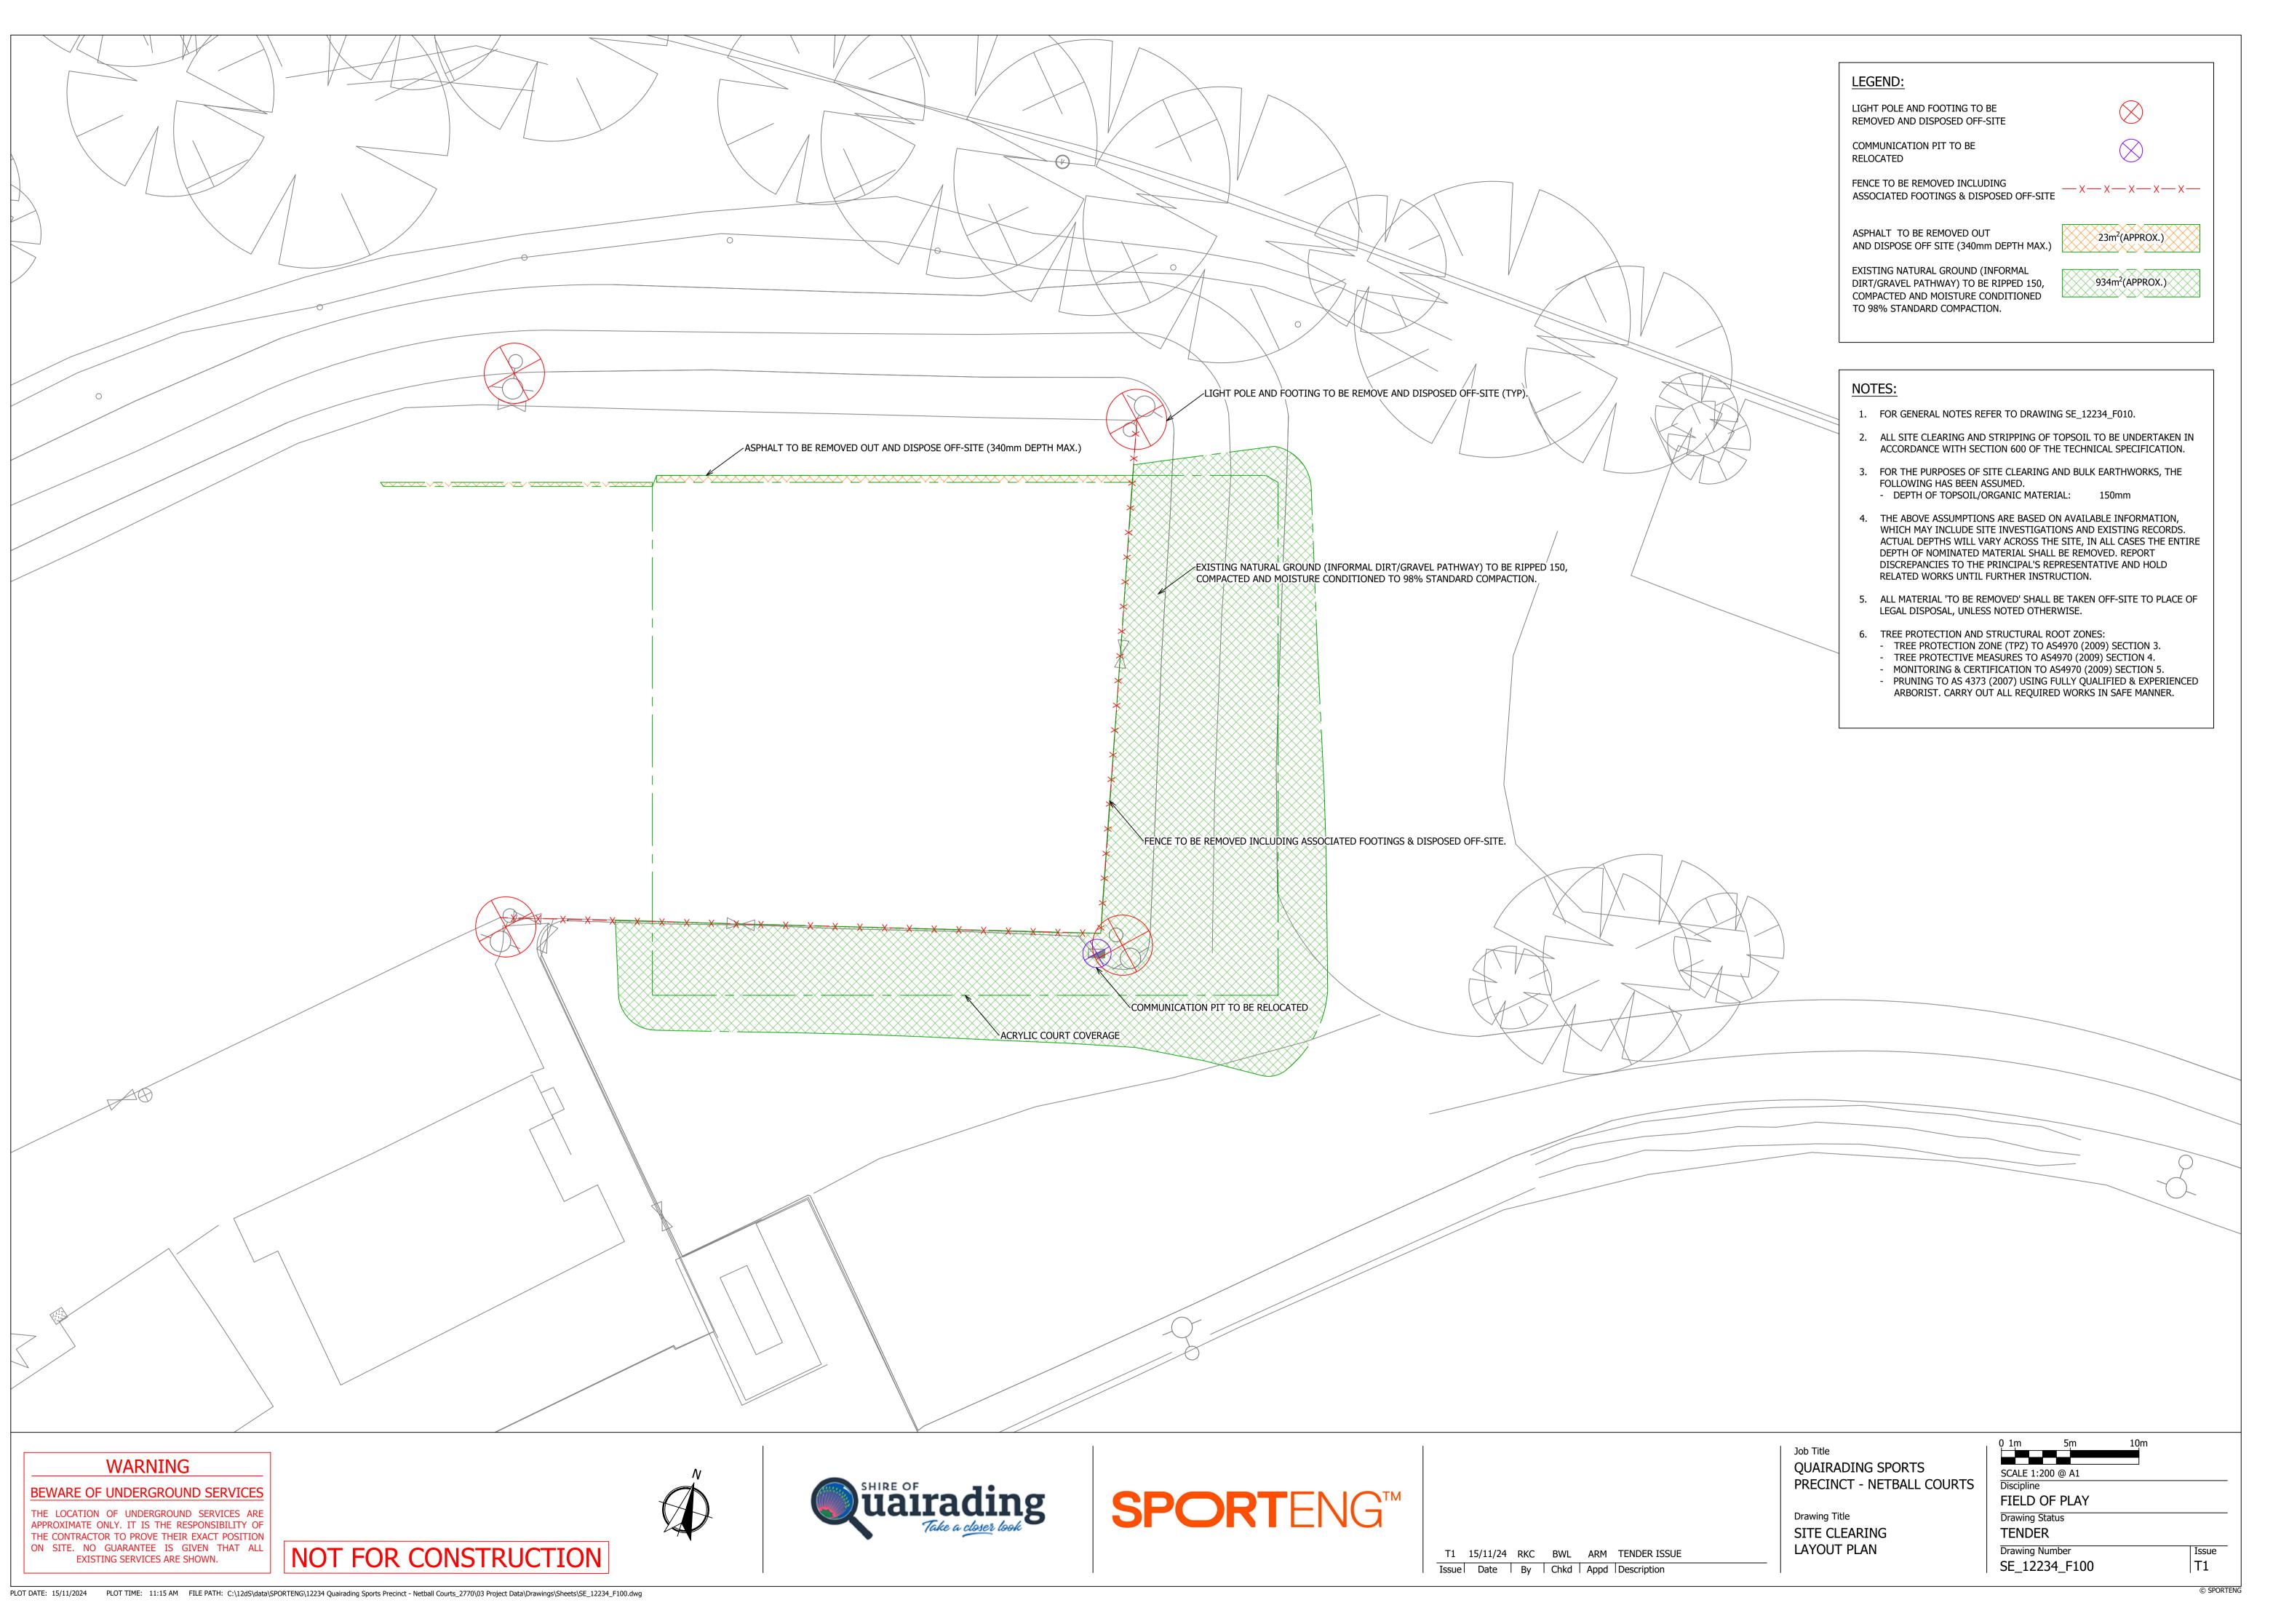

Job Title QUAIRADING SPORTS PRECINCT - NETBALL COURTS	0 1m 5m 10m SCALE 1:200 @ A1 Discipline FIELD OF PLAY
Drawing Title SITE CLEARING	Drawing Status TENDER
LAYOUT PLAN	Drawing NumberIssueSE_12234_F100T1

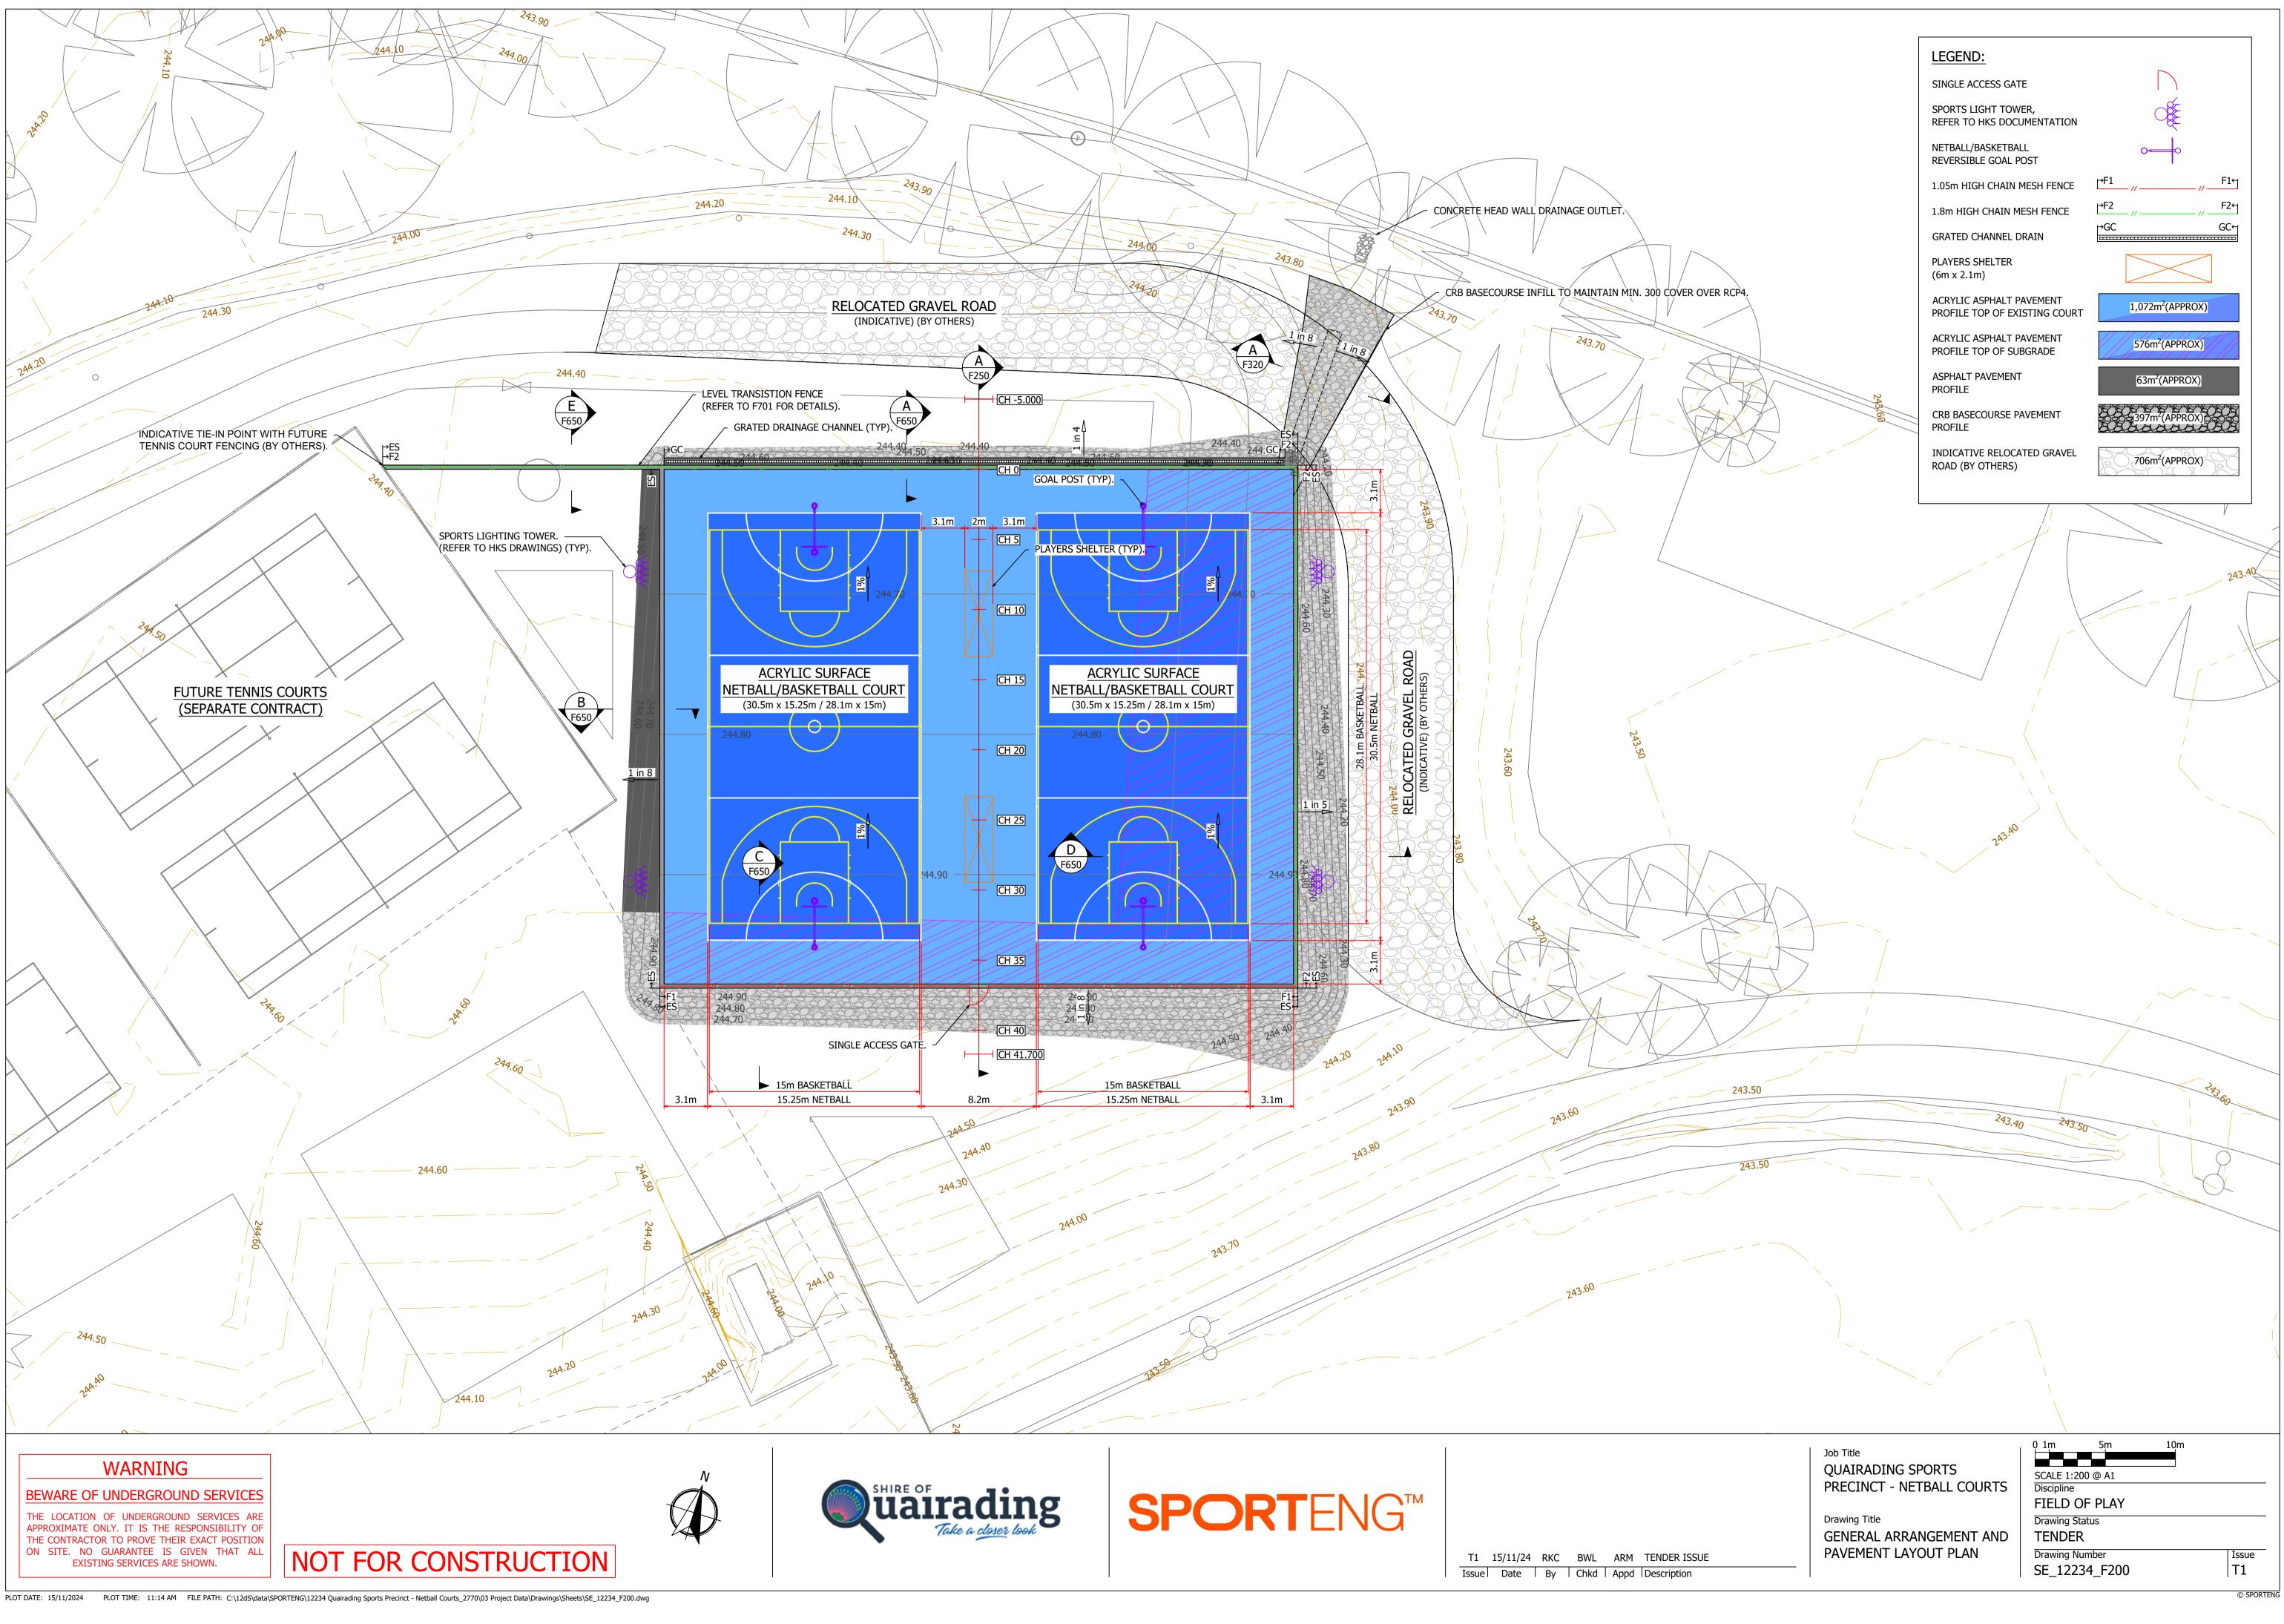

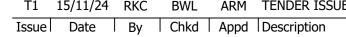



			1%		1 in 8
DATUM RL 244.000					
EXISTING SURFACE	244.400 244.407 244.408 244.410 244.410 244.411 244.413 244.433 244.433	244.461	244.519	244.558	244.596 244.593 244.582 244.582 244.582
DESIGN	244.400 244.611 244.611 244.611 244.611 244.611 244.611 244.661	244.711	244.811	244.911	244.961 244.978 244.583 244.583
CHAINAGE	-1.645 -0.800 -0.650 -0.650 -0.451 -0.451 -0.450 -0.300 0.000 5.000	10.000	20.000	30.000	35.000 36.700 37.000 40.156
HORIZONTAL SCALE 1:100 VERTICAL SCALE 1:20					





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T115/11/24RKCBWLARMTENDER ISSUEIssueDateByChkdAppdDescription




Job Title QUAIRADING SPORTS PRECINCT - NETBALL COURTS


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SITE SECTIONS


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Discipline
FIELD OF PLAY
Drawing Status
TENDER
Drawing Number
SE_12234_F250

Issue T1



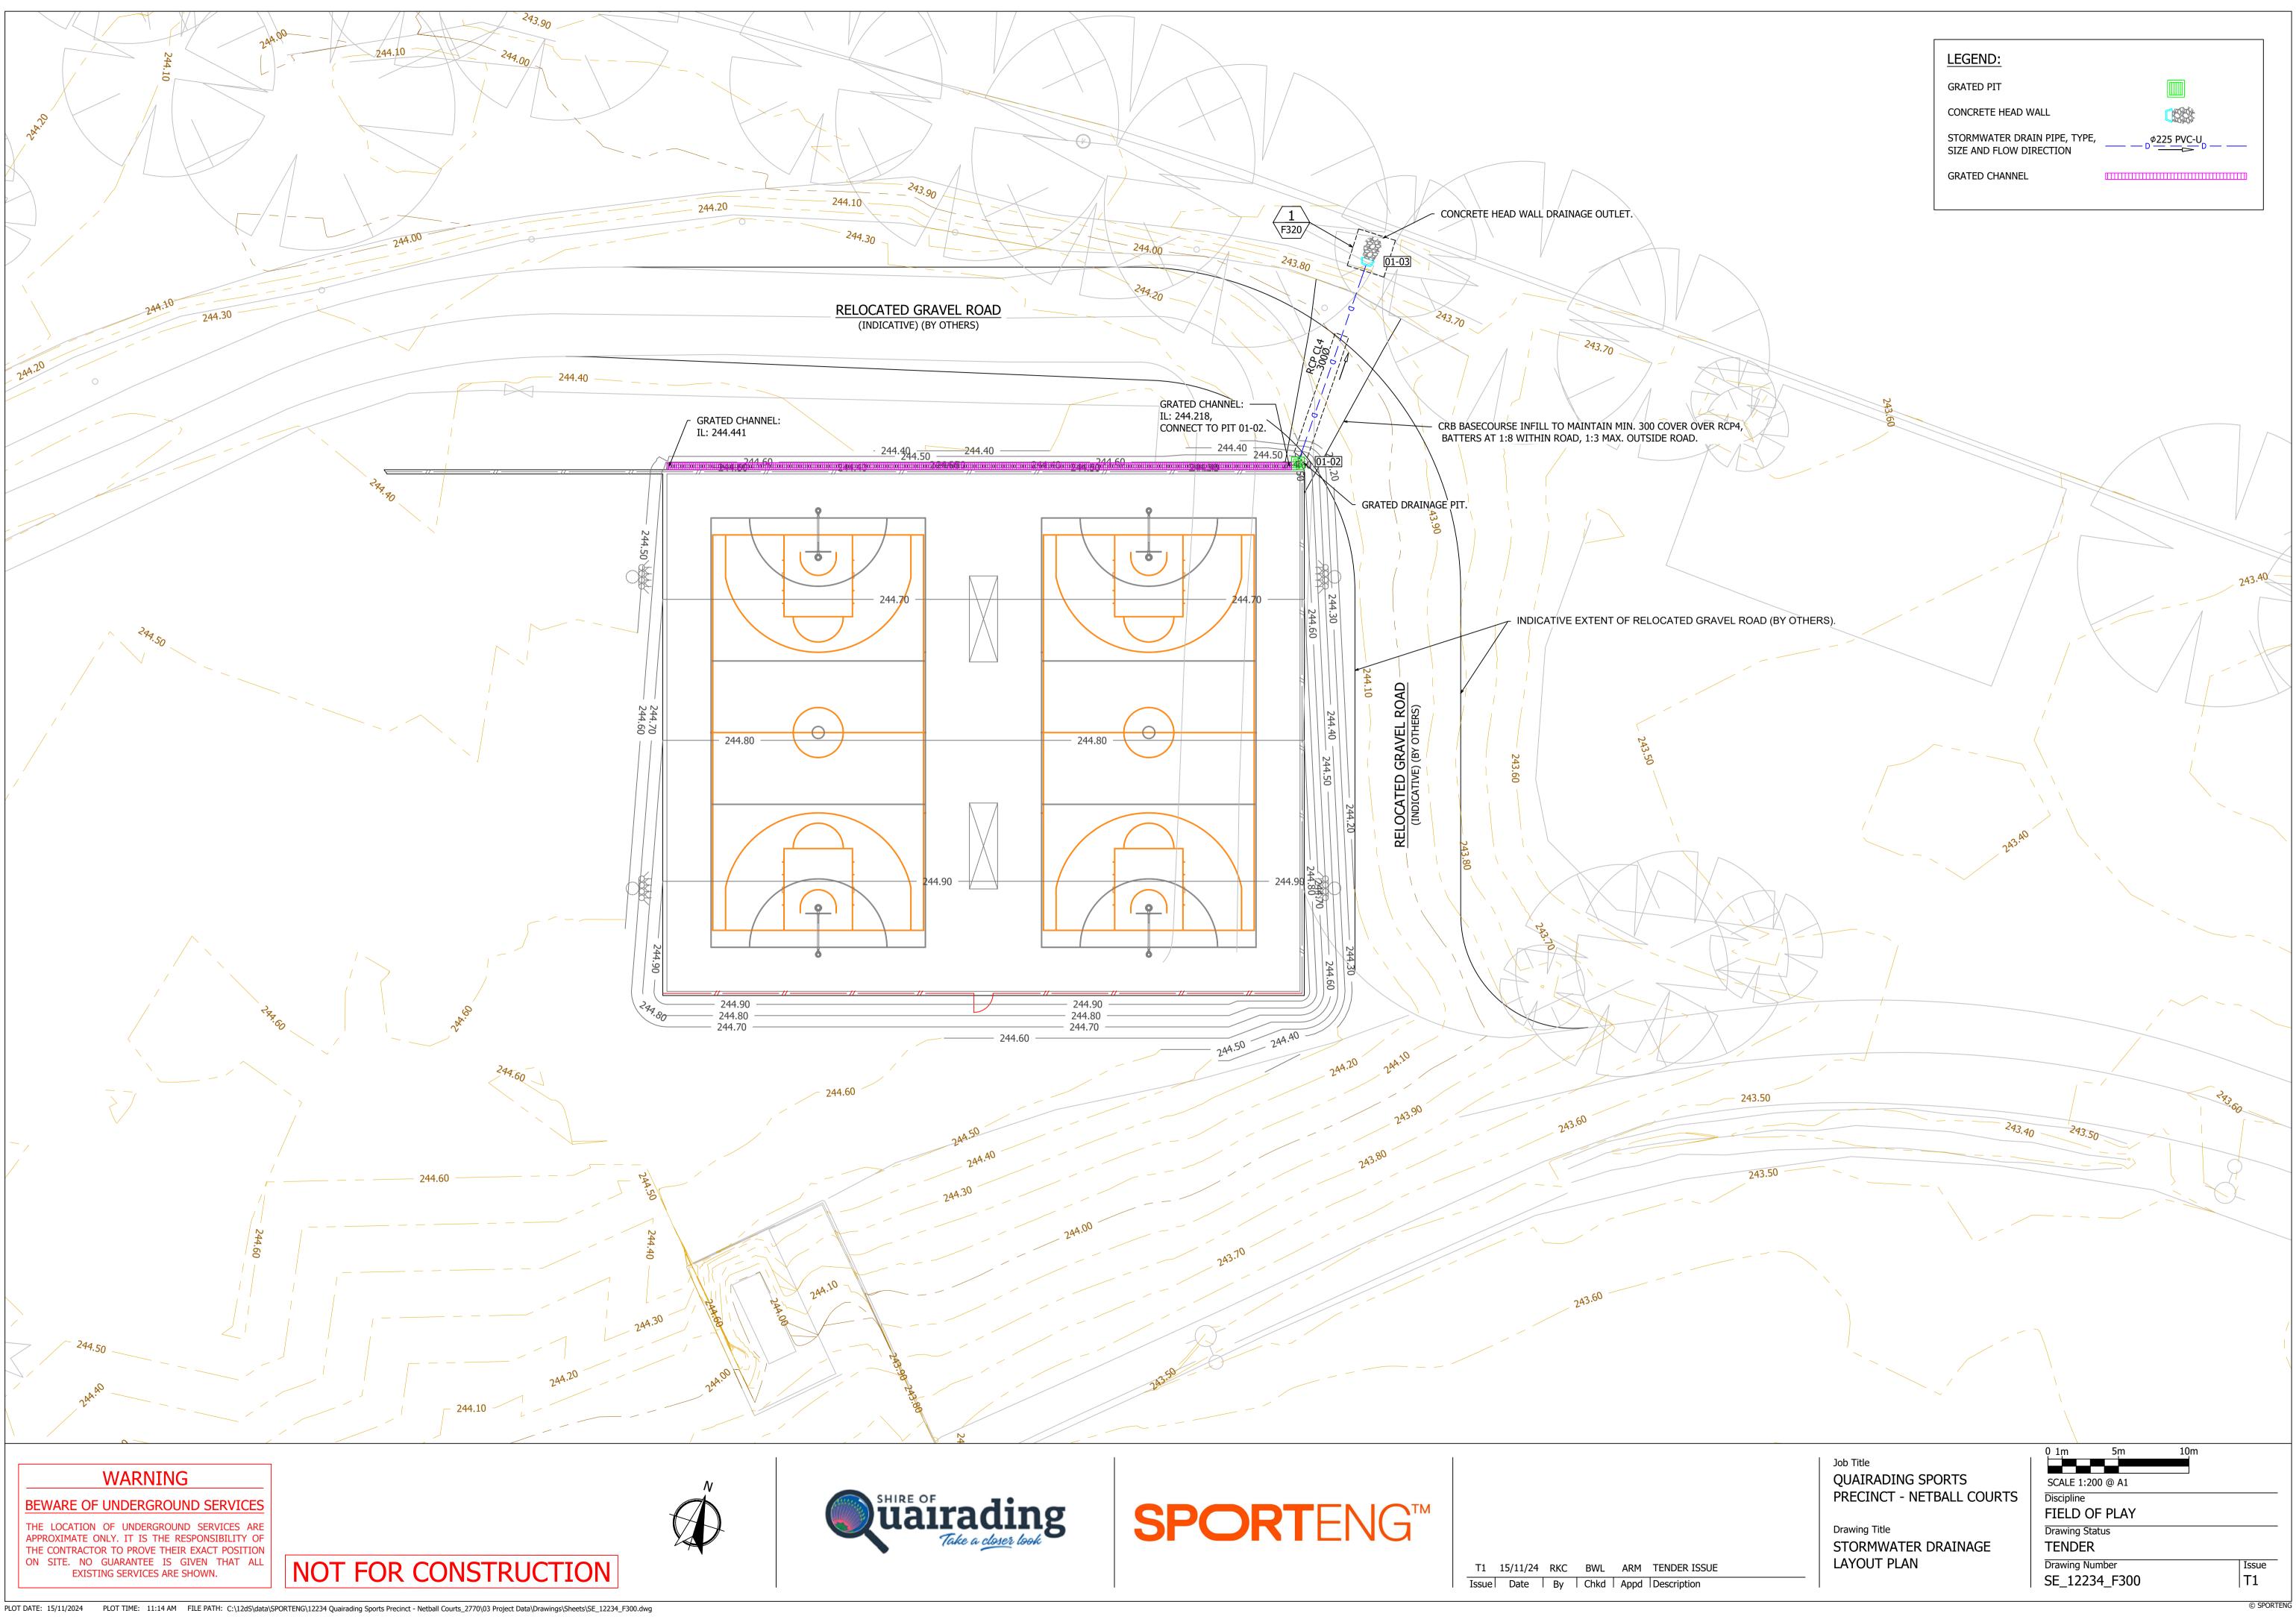

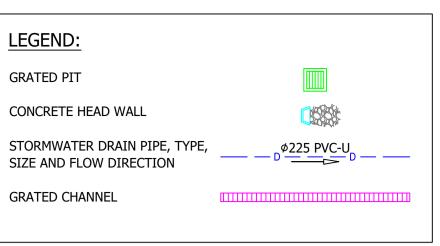

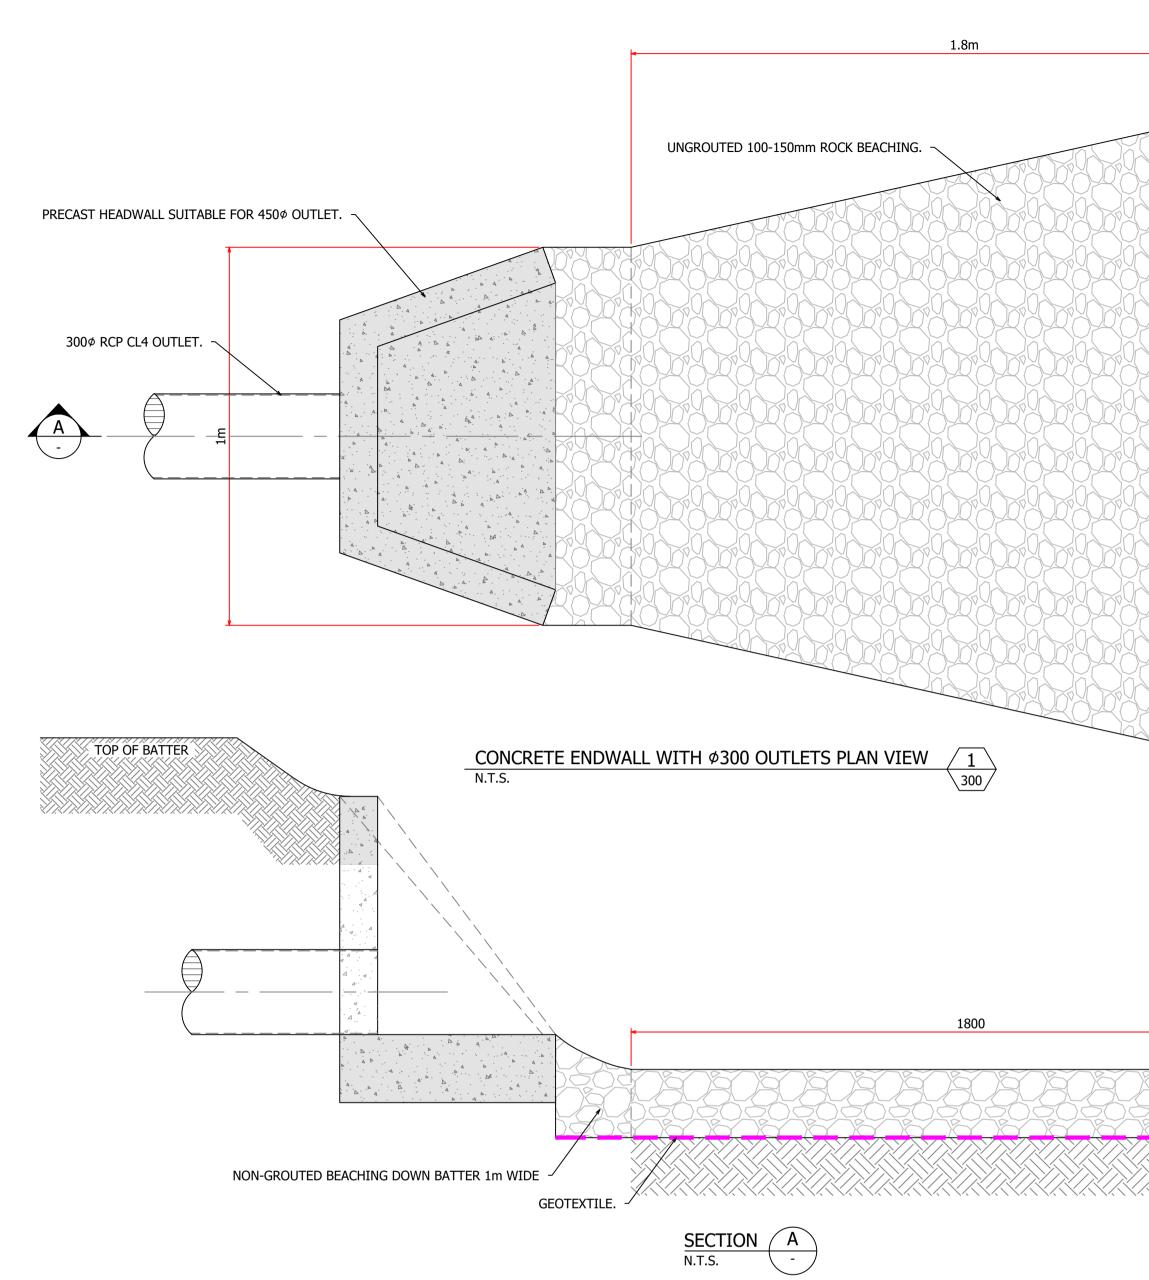PIT NO.	ΡΙΤ ΤΥΡΕ	LENGTH	WIDTH	DEPTH	INVERT RL	PIT COVER RL	FSL	EASTING	NORTHING	COVER TYPE	COVER CLASS
		m	m	m							
01-02	GP - 600x600	0.6	0.6	0.945	243.666	244.611	244.611	538316.872	6458410.985	GRATED	В
01-03	HEADWALL OUTLET	0.3	1.2	0.3	243.606	243.906	243.606	538316.601	6458425.989	N/A	N/A
						LEGEND					
GP	GRATED PIT										
JP	JUNCTION PIT										
SGP	SPOON DRAIN GRATED F	PIT									
PC PIPE TO PIPE CONNECTION											
N/A	N/A NOT APPLICABLE										
OAE	OAE OR APPROVED EQUIVALENT										
FSL	FINISH SURFACE LEVEL										
IL	INVERT LEVEL										
						NOTES					
1. PIT DEPTH	H IS THE MEASUREMENT E	BETWEEN THE PI	T COVER RL AN	D THE INVERT L	EVEL OF THE	PIT					
2. FOR PIT SETOUT DETAILS REFER TO STORMWATER DETAILS DRAWING											
<ul> <li>CONTRACTOR TO CONFIRM ALL CONNECTIONS INTO EXISTING DRAINAGE PRIOR TO COMMENCEMENT OF DRAINAGE INSTALLATION TO ENSURE:</li> <li>INVERT RL MATCHES THAT SHOWN ON THE DRAWINGS</li> <li>DOWNSTREAM OUTET SIZE MATCHES THAT SHOWN ON THE DRAWINGS</li> </ul>											

- DOWNSTREAM OUTLETS ARE FREE FROM BLOCKAGE AND FREE-FLOWING.





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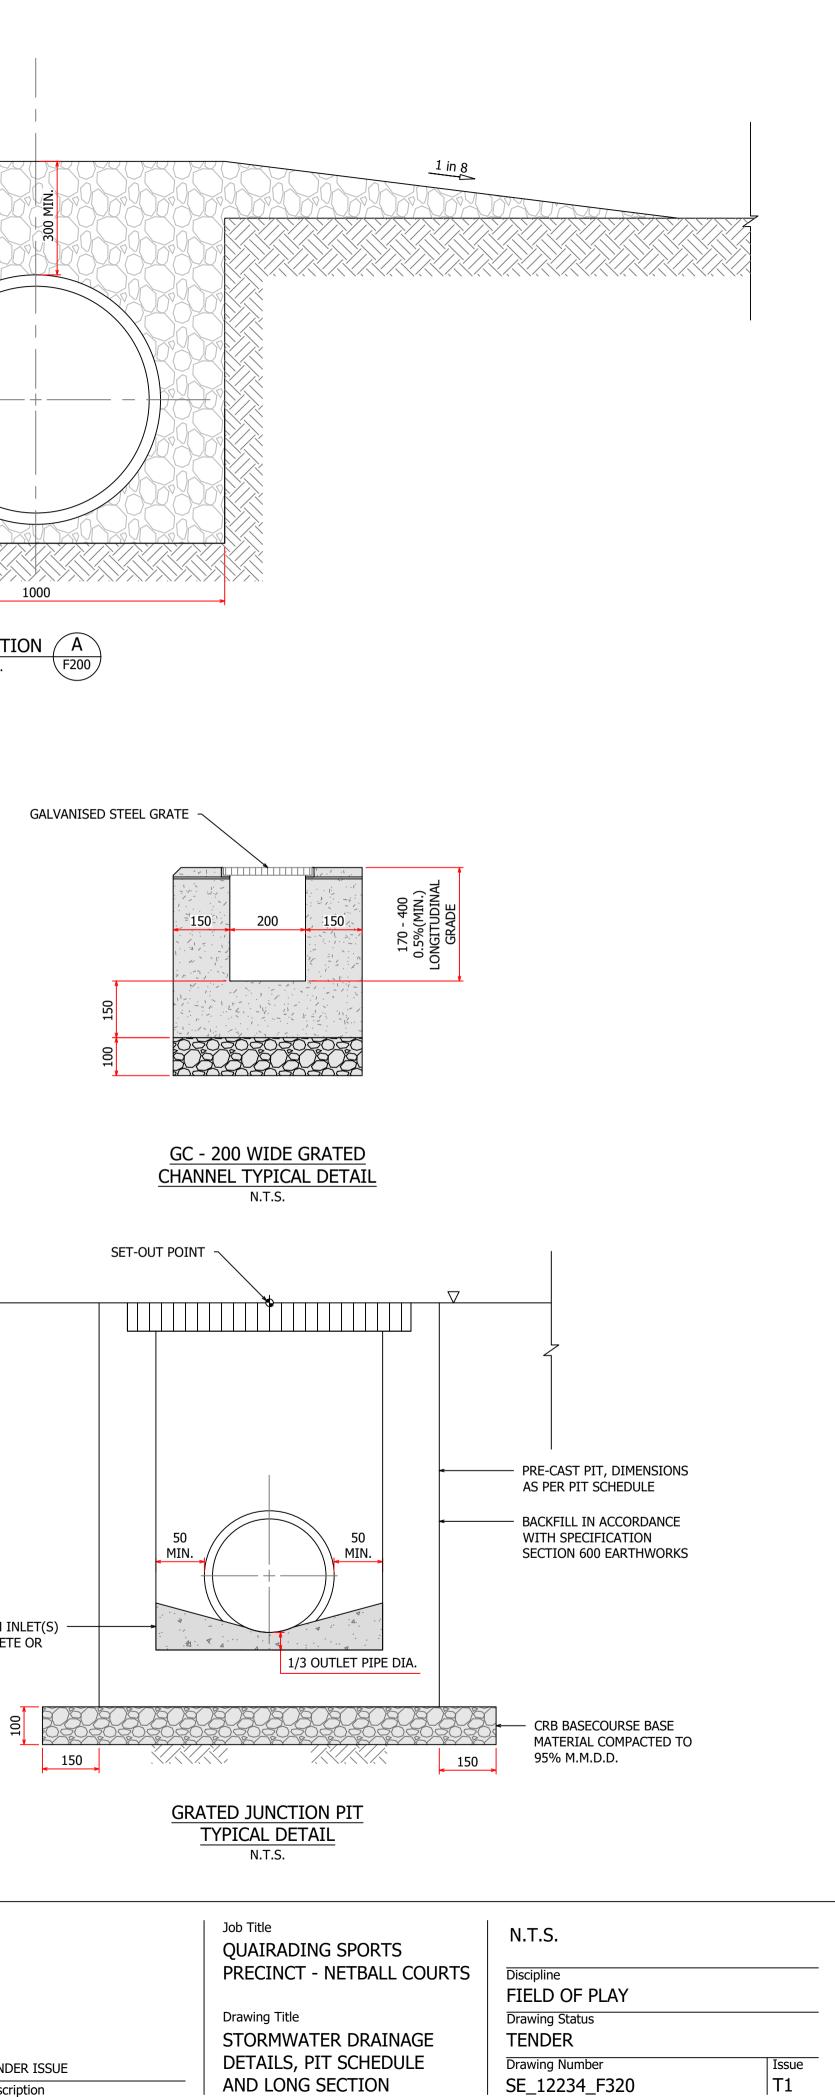



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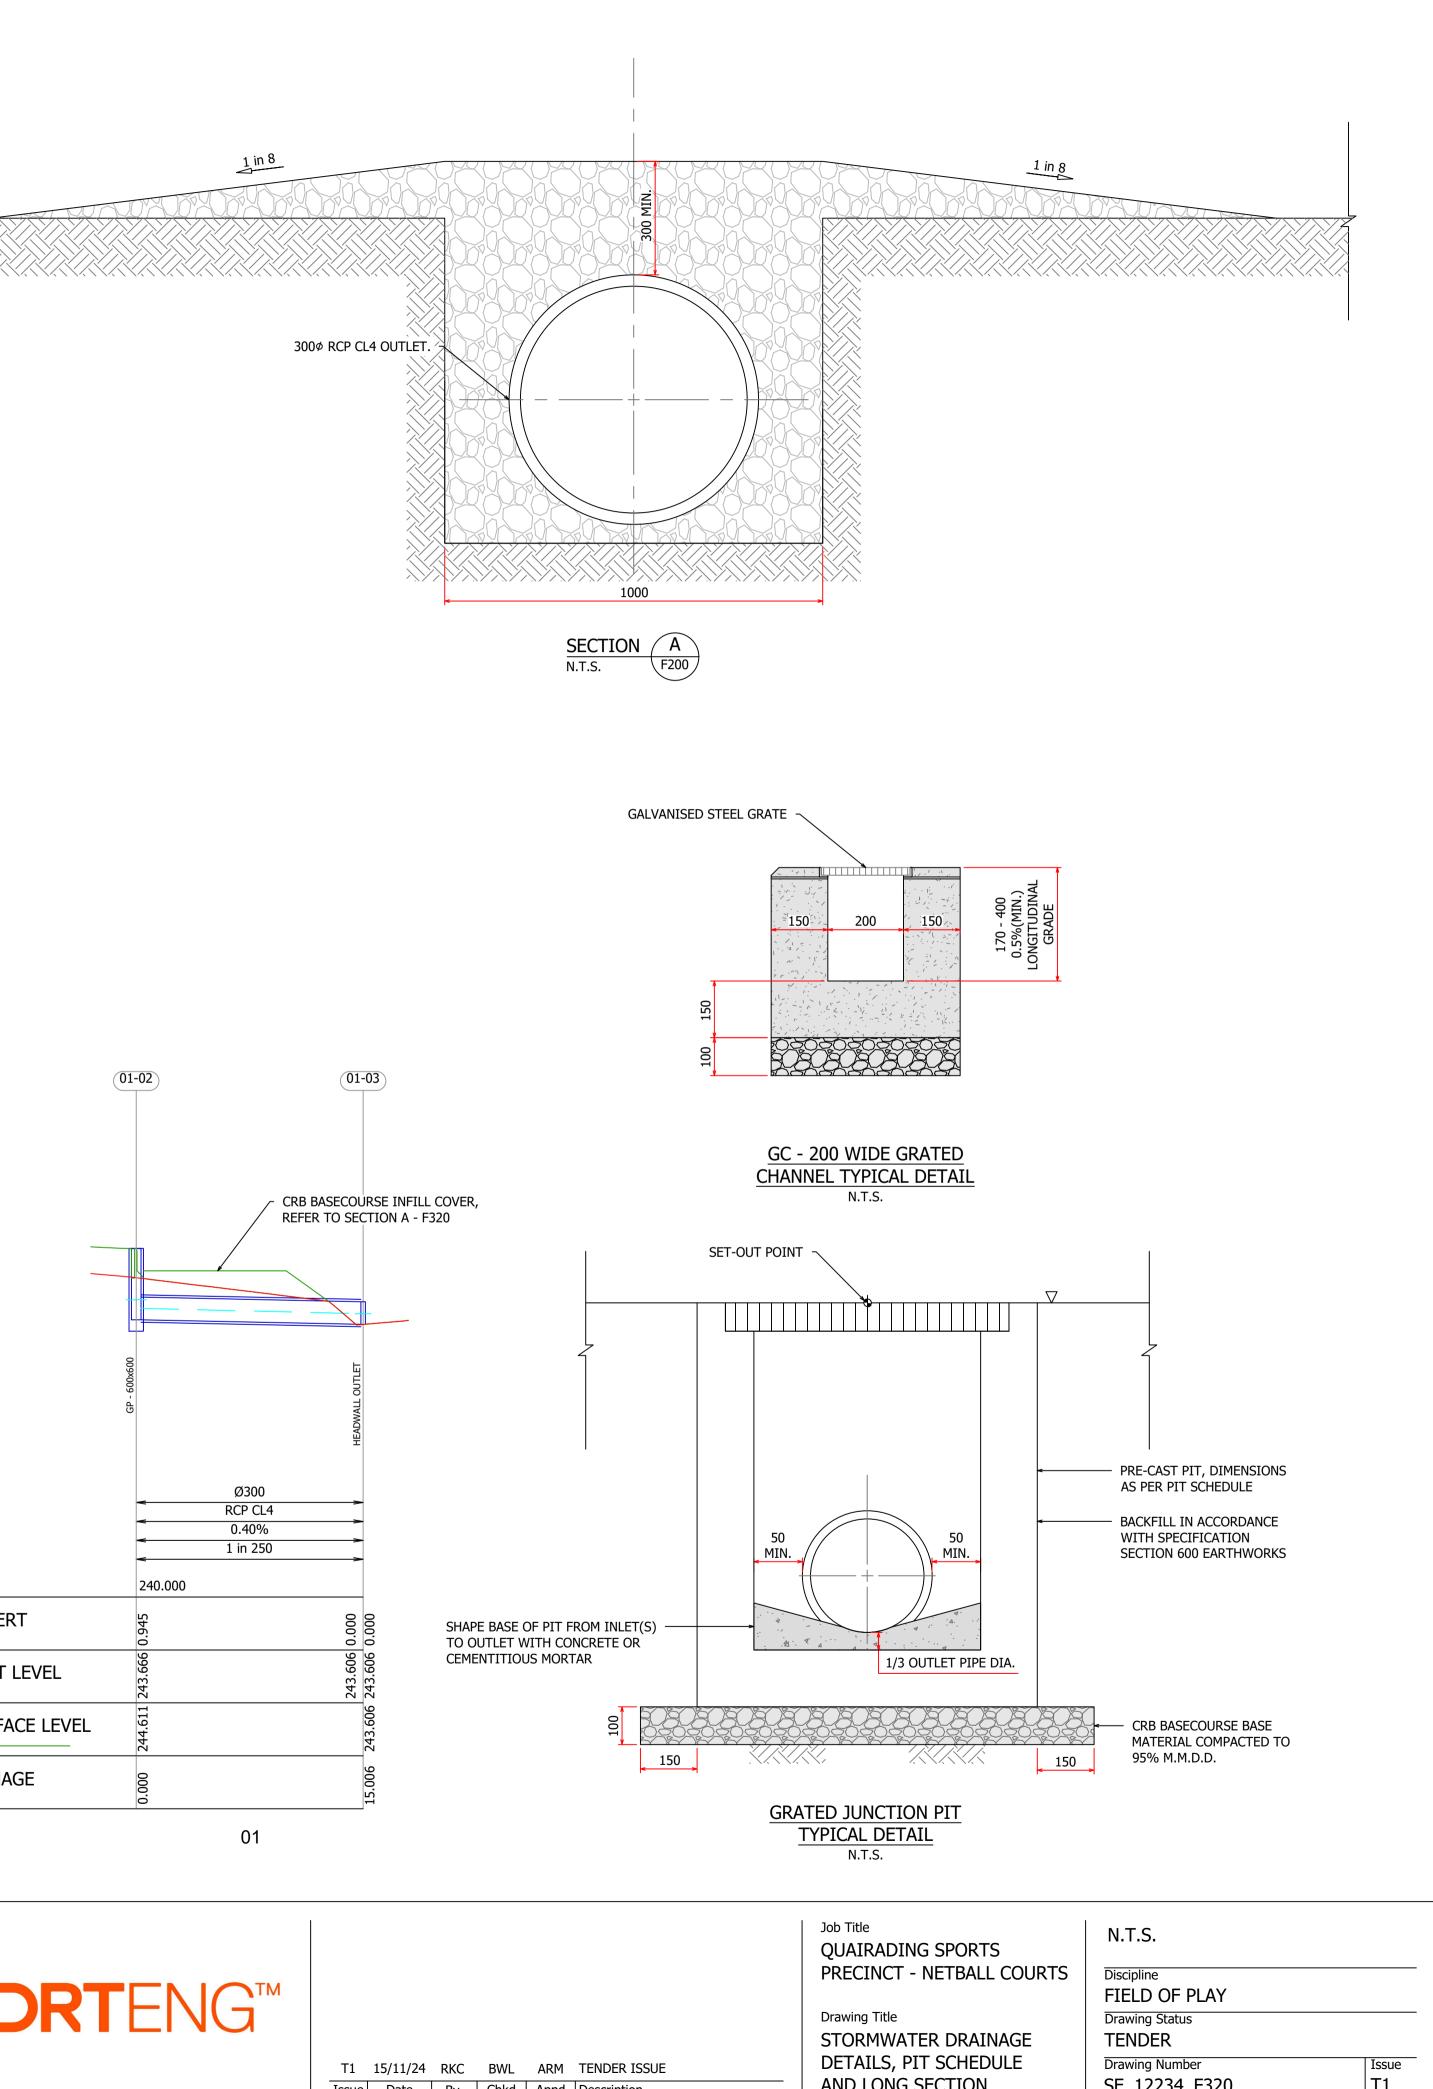



REMARKS



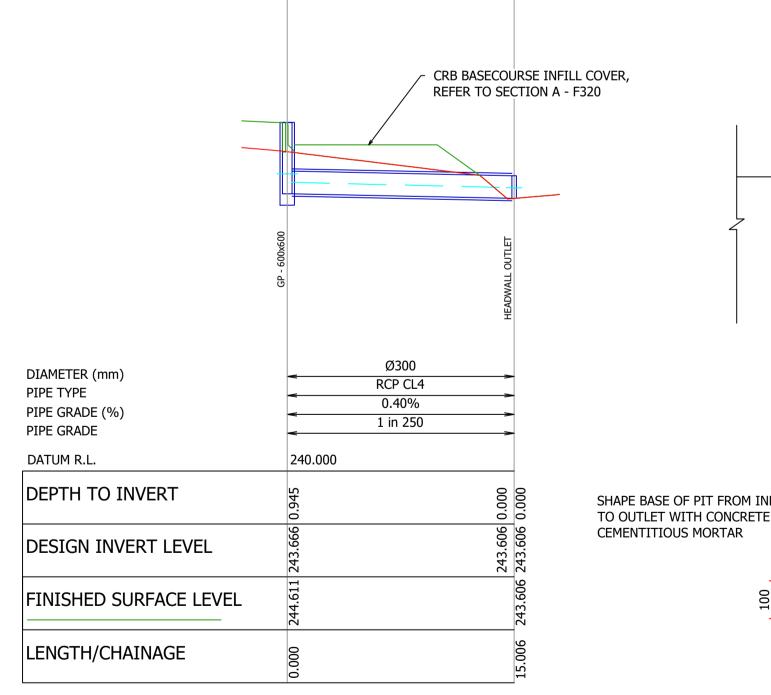

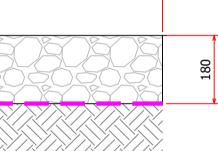
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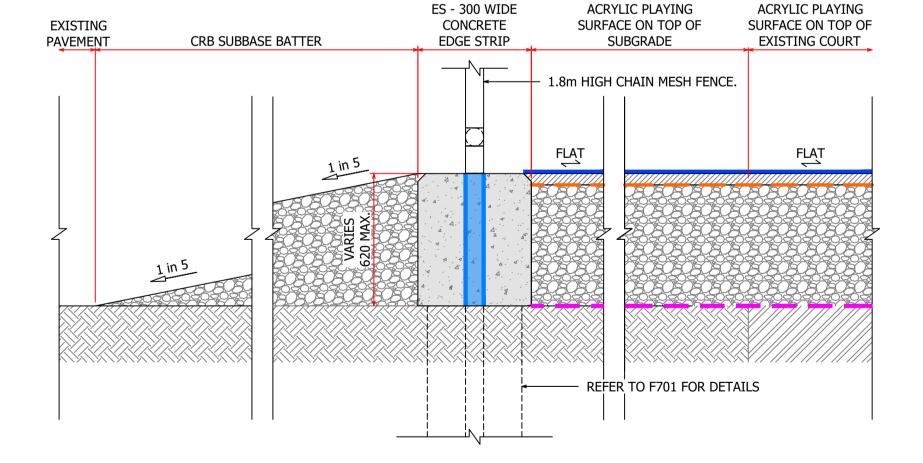
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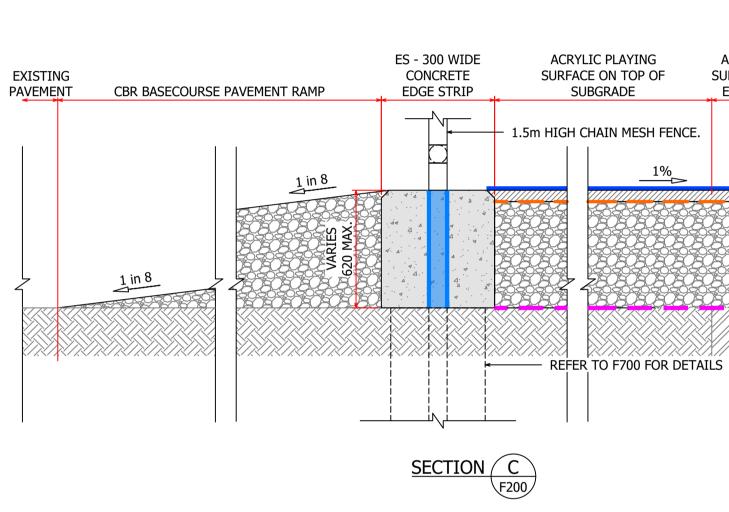


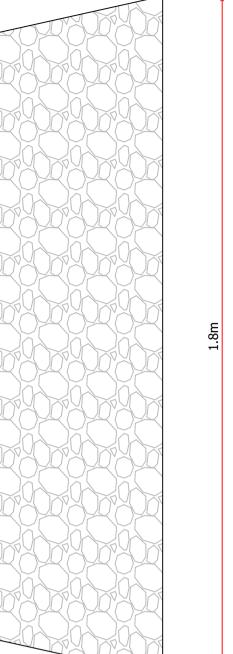

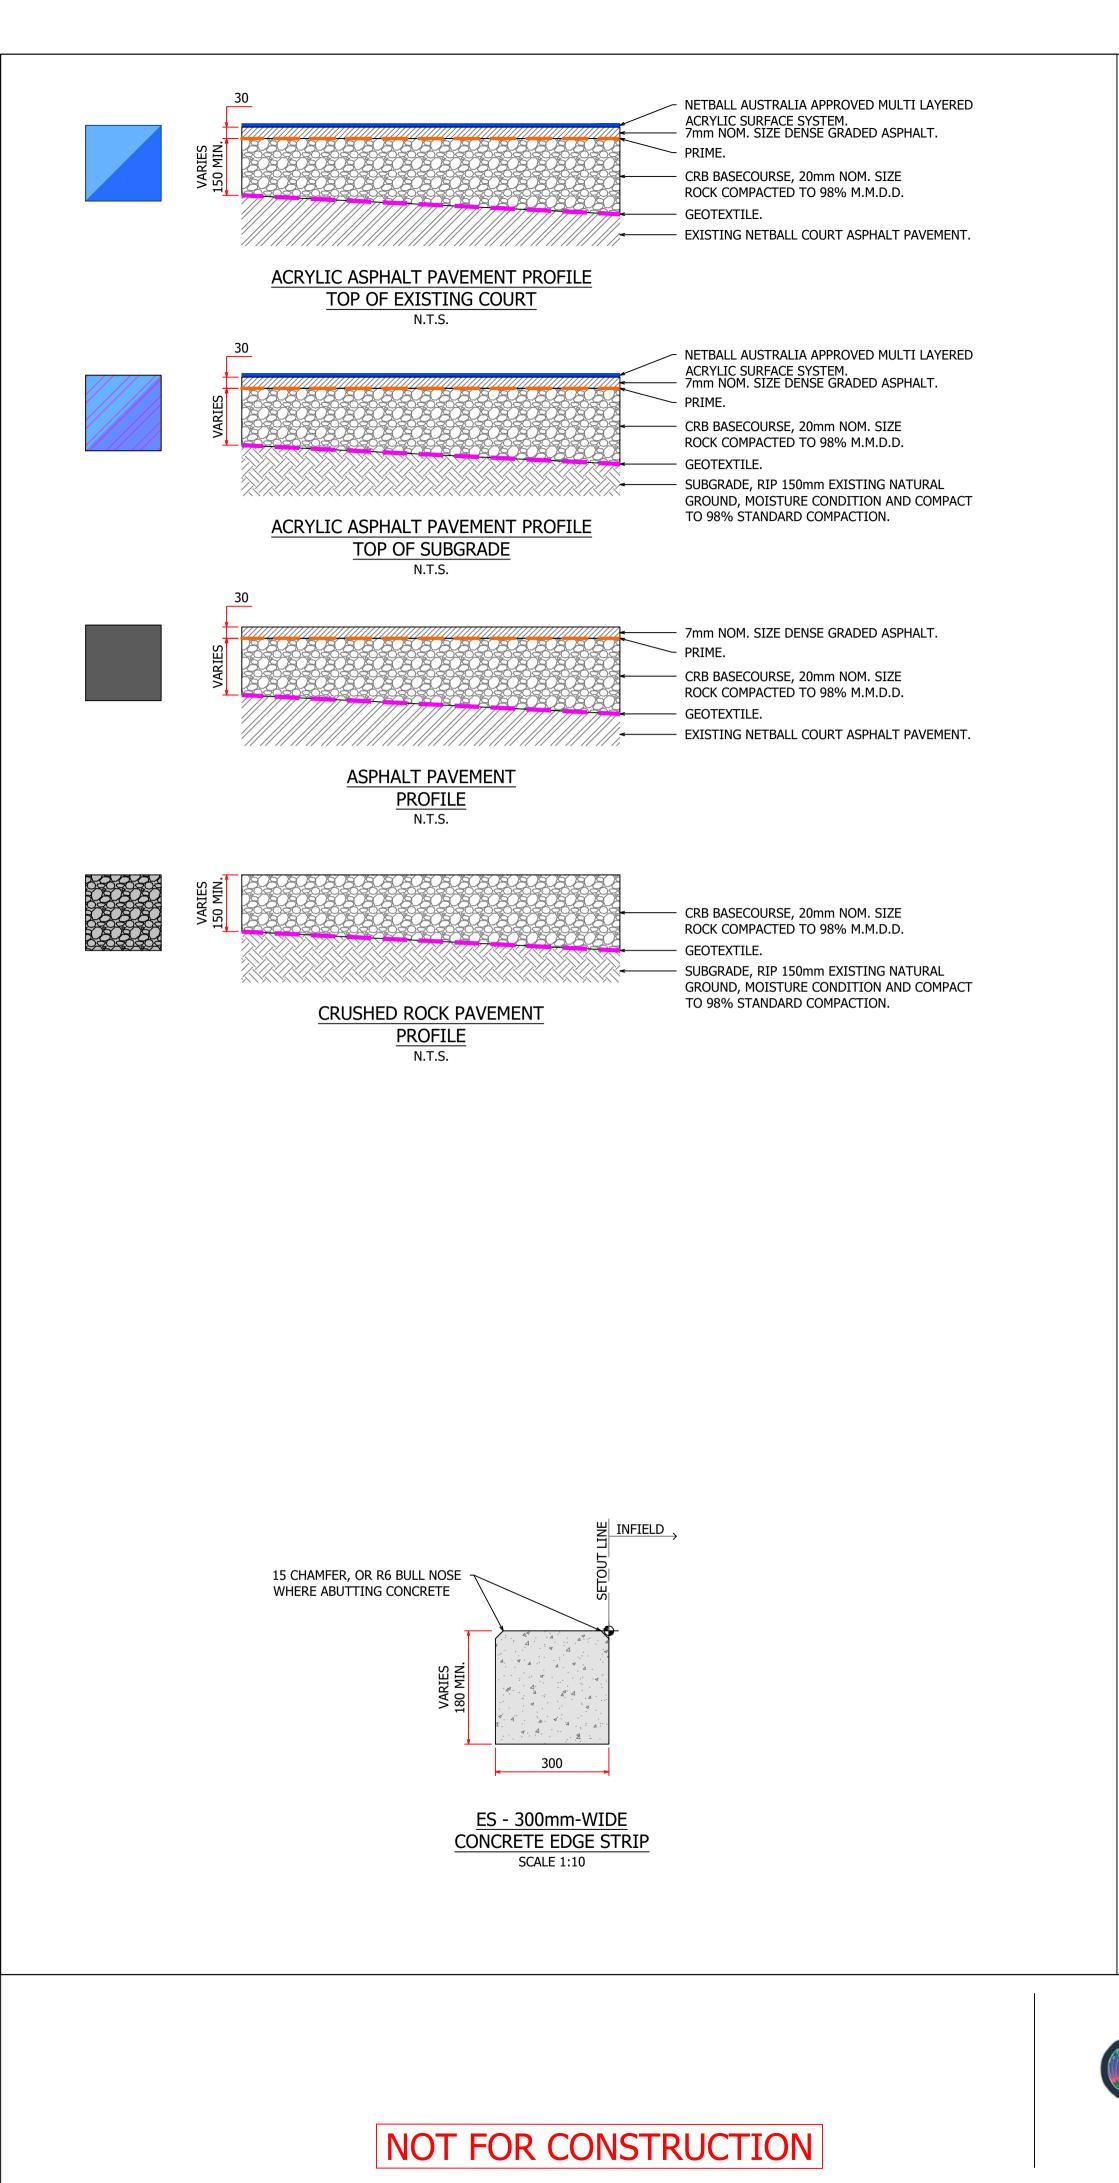




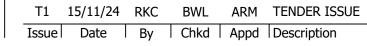






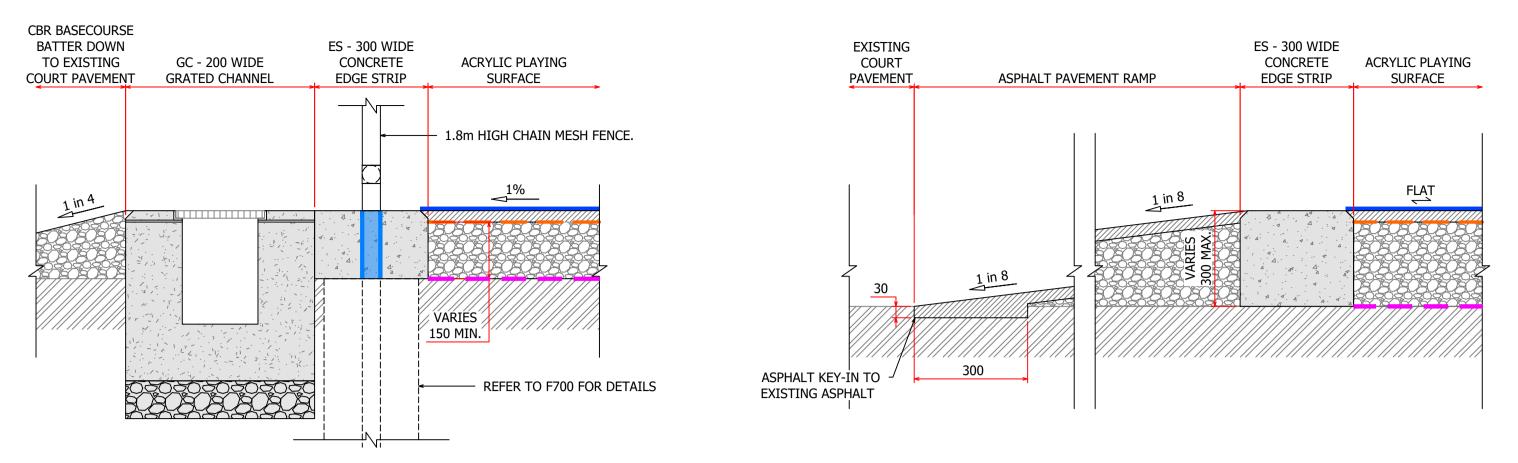



ACRYLIC PLAYING SURFACE ON TOP OF EXISTING COURT

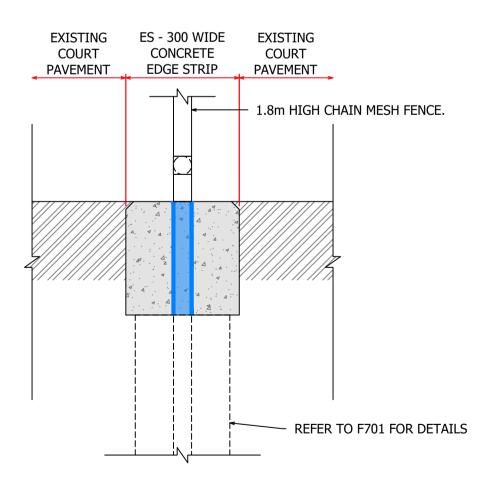


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Job Title QUAIRADING SPORTS PRECINCT - NETBALL COURTS


Drawing Title PAVEMENT PROFILES AND DETAILS N.T.S.

FIELD OF PLAY
Drawing Status
Drawing Number SE_12234_F650

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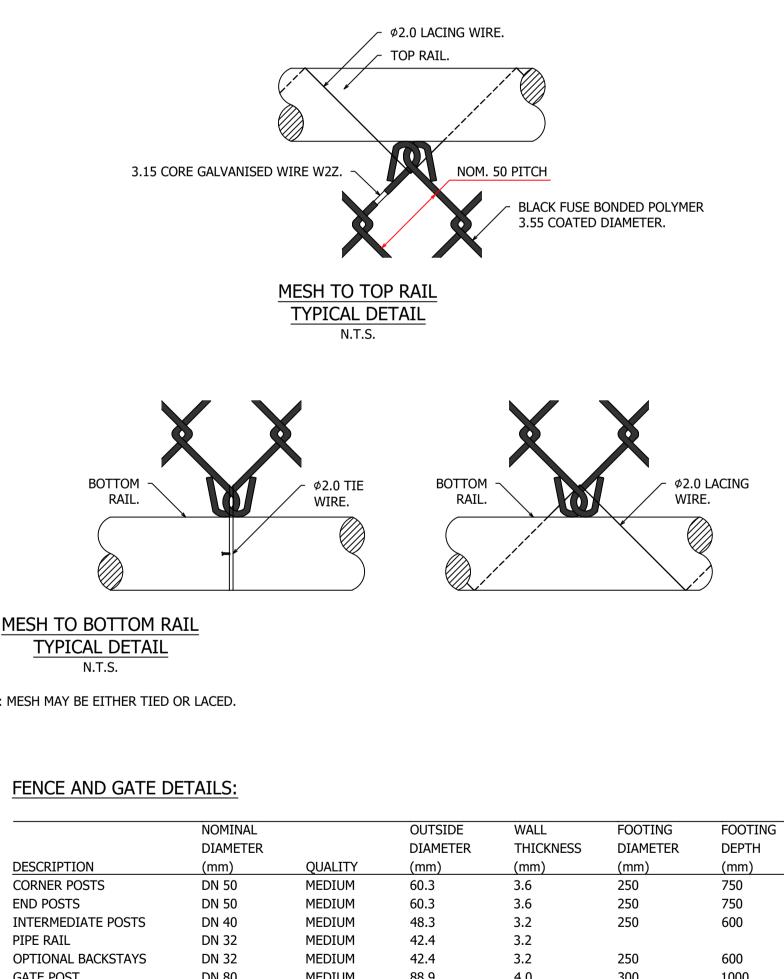


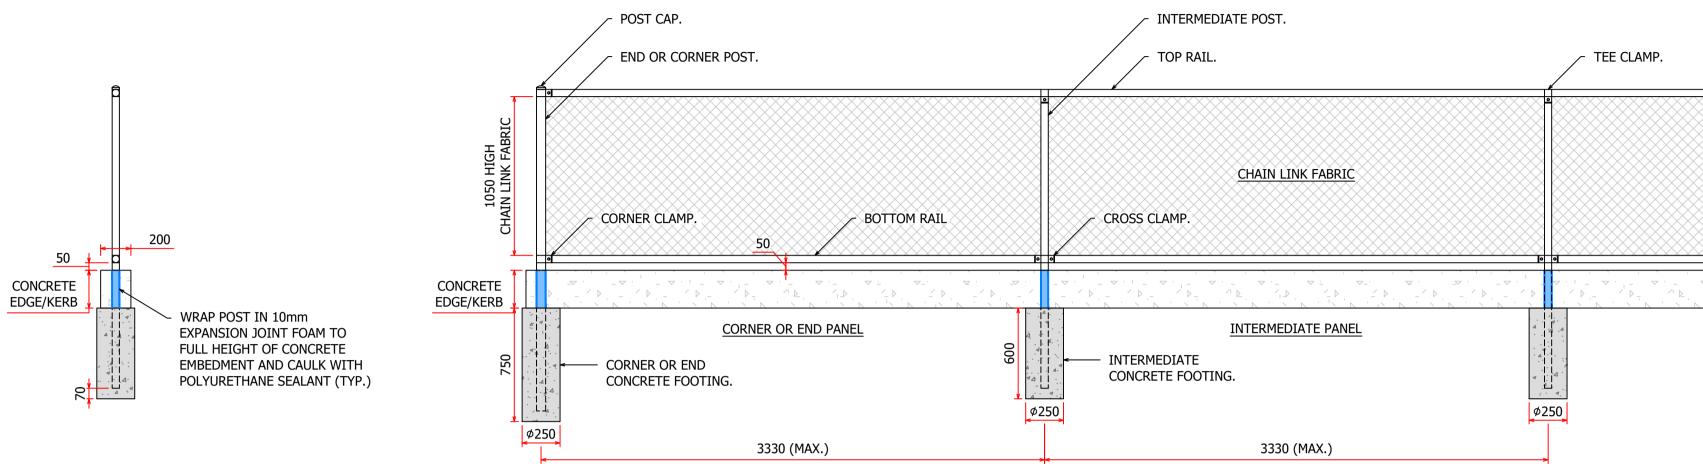

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1350 WIDE SINGE GATE TYPICAL ELEVATION N.T.S.

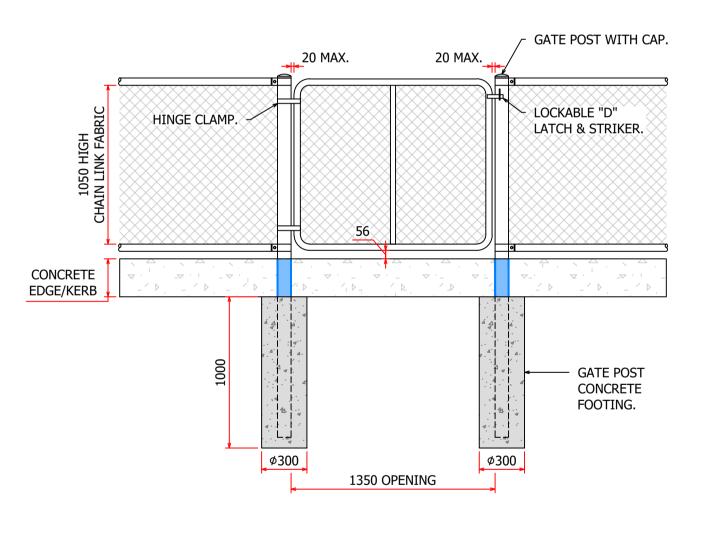

MESH TO BOTTOM RAIL TYPICAL DETAIL

NOTE: MESH MAY BE EITHER TIED OR LACED.

	NOMINAL
	DIAMETER
DESCRIPTION	(mm)
CORNER POSTS	DN 50
END POSTS	DN 50
INTERMEDIATE POSTS	DN 40
PIPE RAIL	DN 32
OPTIONAL BACKSTAYS	DN 32
GATE POST	DN 80
GATE OUTER FRAME	DN 32
GATE INNER FRAME	DN 25



NOTE.
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- 1. INSTALLATION OF FENCE SHALL BE IN ACCORDANCE WITH AS 1725.5-2010 AND THE TECHNICAL SPECIFICATION SECTION 8000.
- 2. FENCE CONSTRUCTION SHALL BE TYPE 2: HEAVY DURABILITY CONSTRUCTED WITHDN 50 POSTS AND DN40 RAILS.
- 3. NOMINAL FENCE HEIGHT SHALL BE 1050mm (CHAIN LINK FABRIC HEIGHT).
- 4. ALL PIPE POSTS AND RAILS SHALL BE CLASS 1 (MEDIUM QUALITY) AS PER AS1074-1989.
- 5. JOINTS ONLY PERMITTED IN TOP RAIL AT NOT LESS THAN 6000mm INTERVALS.
- 6. CHAIN LINK FABRIC SHALL BE: 50mm PITCH, 3.15mm WIRE, KNUCKLE-KNUCKLE (KK) SELVEDGE, BLACK FUSION BONDED COATED.
- 7. LACING WIRE SHALL BE BLACK FUSE-BONDED POLYMER-COATED, IN ACCORDANCE WITH AS 1725.5 CLAUSE 3.7(c).
- 8. ALL STEEL ELEMENTS SHALL BE POWDER COATED BLACK, UNLESS NOTED OTHERWISE.
- 9. VARIATIONS TO THE DESIGN MUST BE VERIFIFIED BY A STRUCTURAL ENGINEER.


		4.0	200	1000	
MEDIUM		4.0	300	1000	
MEDIUM	42.4	3.2			
MEDIUM	33.7	3.2			
	1 7.6 7.41.		1		
	Job Title				

### QUAIRADING SPORTS PRECINCT - NETBALL COURTS

Drawing Title 1.05m HIGH FENCE DETAILS

Discipline
FIELD OF PLAY
Drawing Status
TENDER
Drawing Number
SE_12234_F700

Issue T1

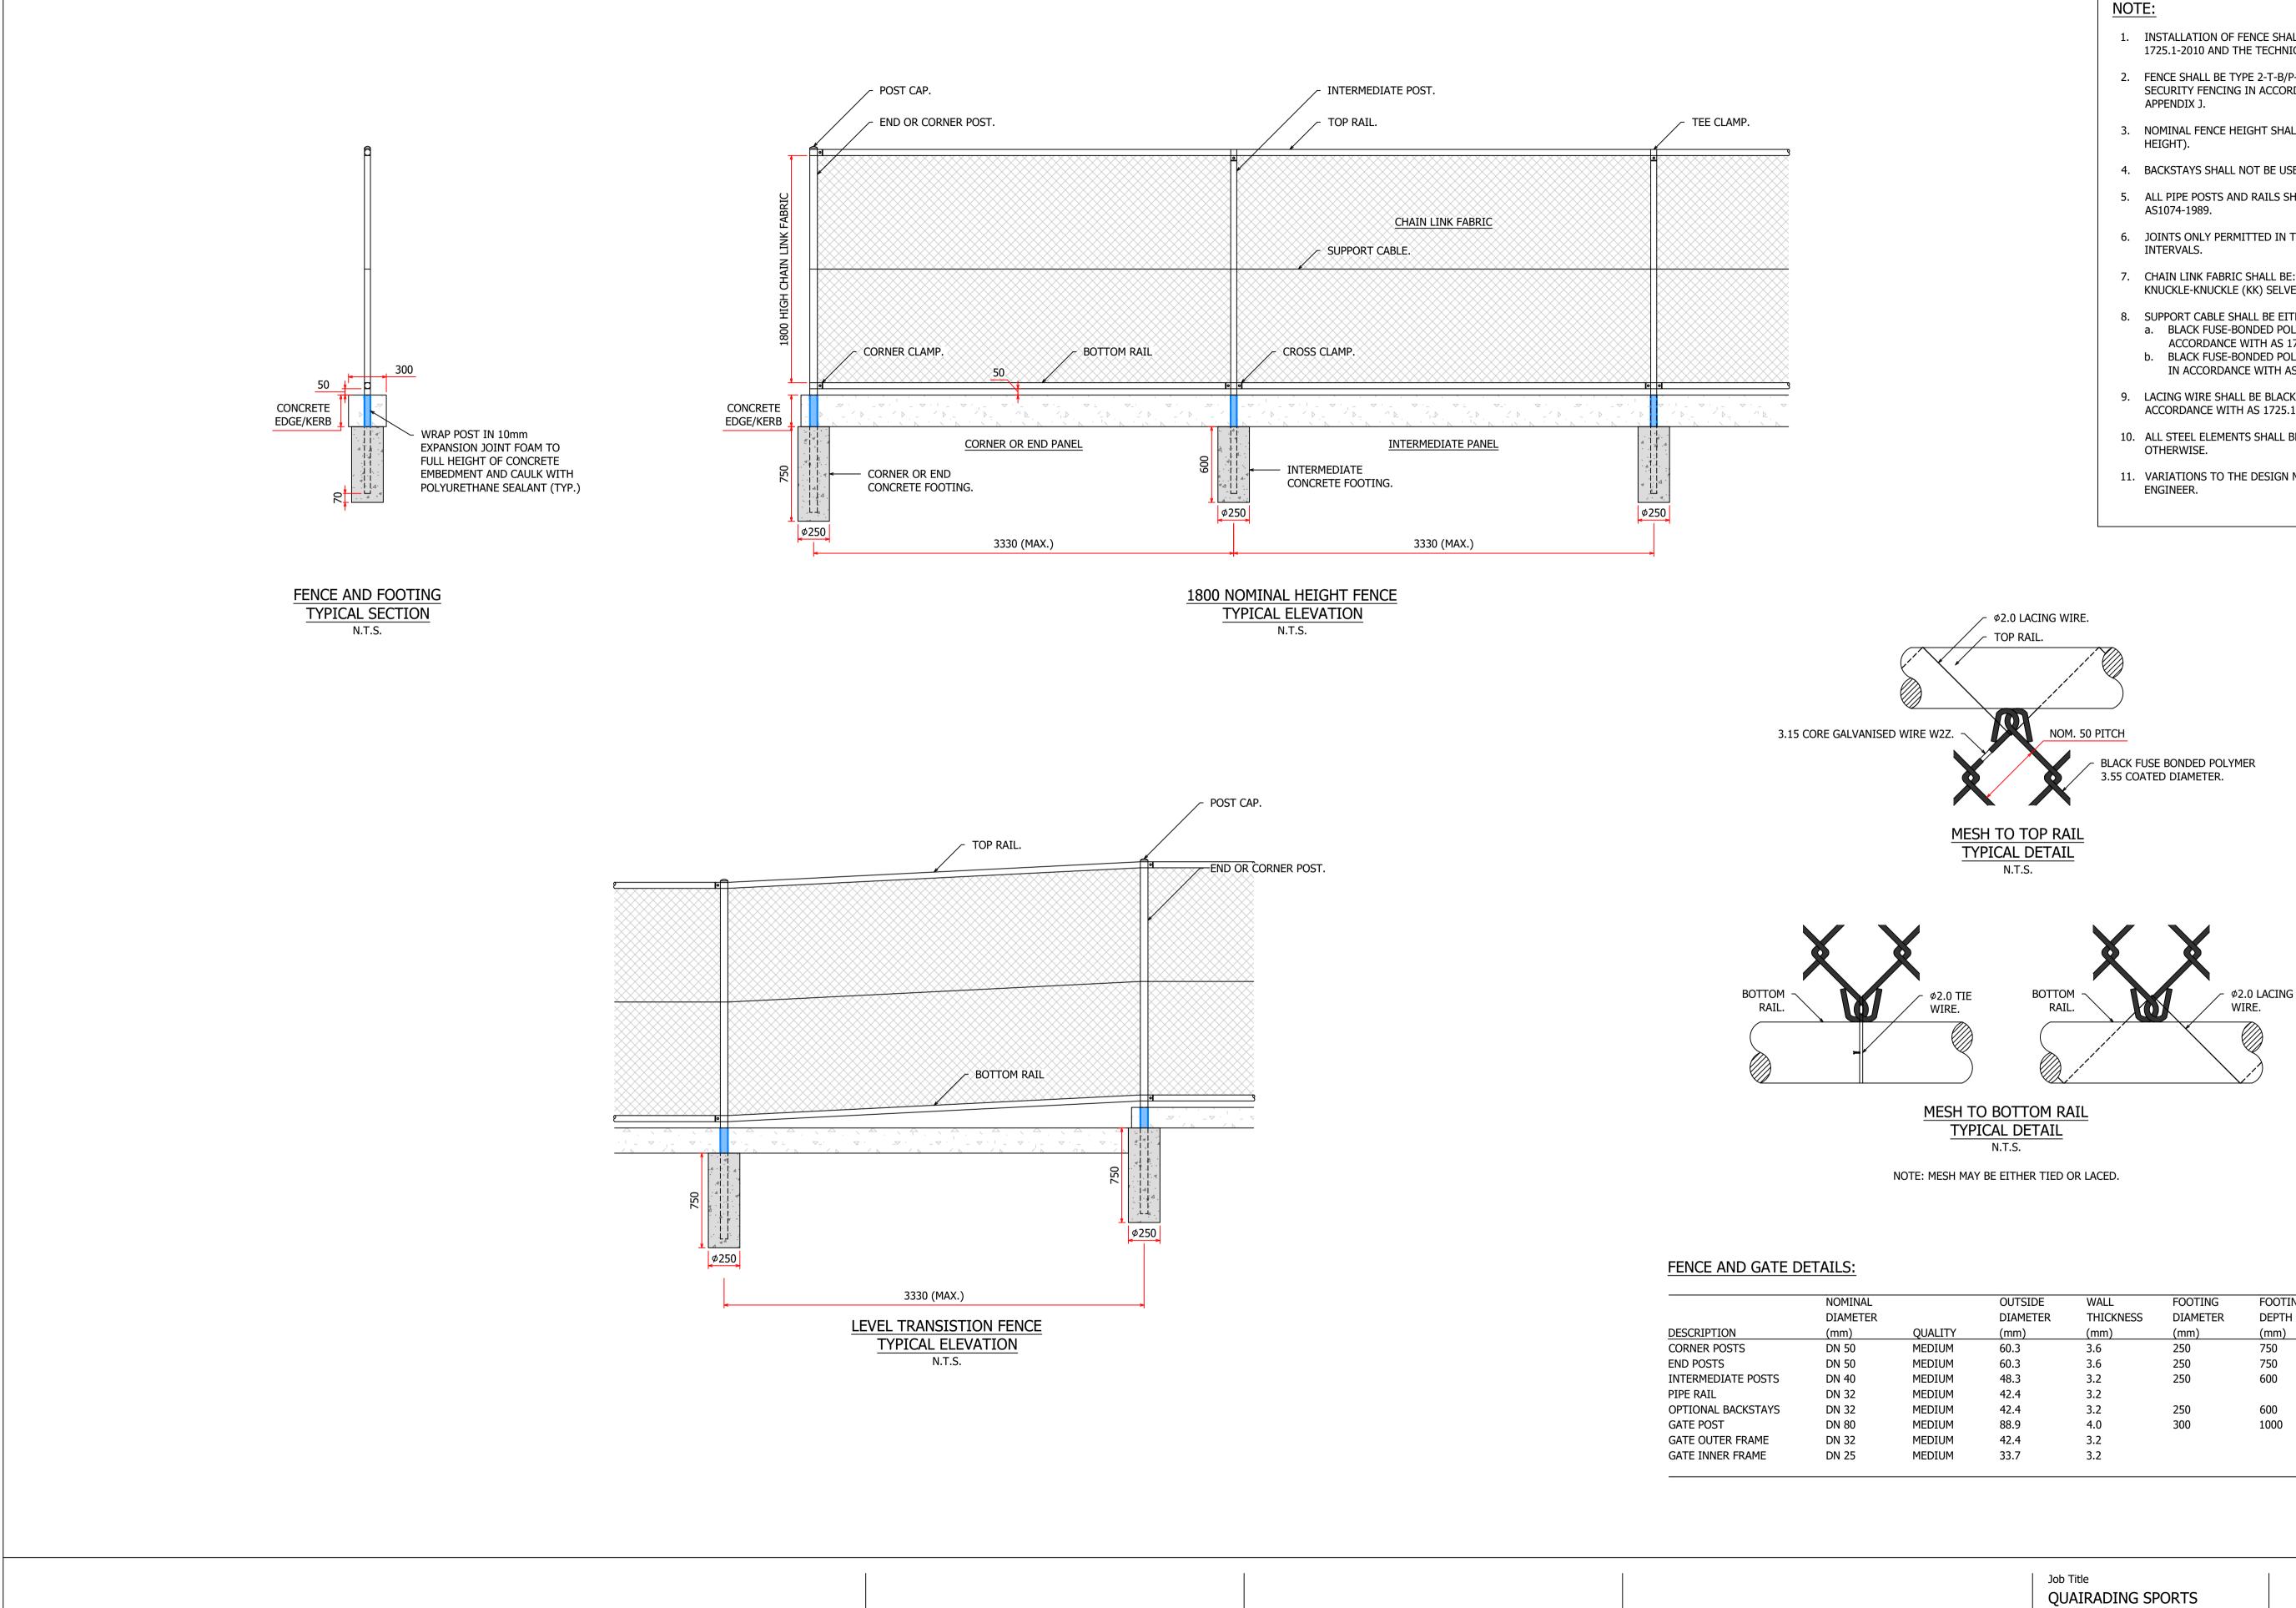



PLOT DATE: 15/11/2024 PLOT TIME: 11:13 AM FILE PATH: C:\12dS\data\SPORTENG\12234 Quairading Sports Precinct - Netball Courts\_2770\03 Project Data\Drawings\Sheets\SE\_12234\_F701.dwg

	NOMINAL		OUTSIDE	WALL	FOOTING	FOOTING
	DIAMETER		DIAMETER	THICKNESS	DIAMETER	DEPTH
DESCRIPTION	(mm)	QUALITY	(mm)	(mm)	(mm)	(mm)
CORNER POSTS	DN 50	MEDIUM	60.3	3.6	250	750
END POSTS	DN 50	MEDIUM	60.3	3.6	250	750
INTERMEDIATE POSTS	DN 40	MEDIUM	48.3	3.2	250	600
PIPE RAIL	DN 32	MEDIUM	42.4	3.2		
OPTIONAL BACKSTAYS	DN 32	MEDIUM	42.4	3.2	250	600
GATE POST	DN 80	MEDIUM	88.9	4.0	300	1000
GATE OUTER FRAME	DN 32	MEDIUM	42.4	3.2		
GATE INNER FRAME	DN 25	MEDIUM	33.7	3.2		



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T1 15/11/24 RKC BWL ARM TENDER ISSUE Issue Date By Chkd Appd Description



- 1. INSTALLATION OF FENCE SHALL BE IN ACCORDANCE WITH AS 1725.1-2010 AND THE TECHNICAL SPECIFICATION SECTION 8000.
- 2. FENCE SHALL BE TYPE 2-T-B/P-T TOP AND BOTTOM RAIL, PLAIN TOP SECURITY FENCING IN ACCORDANCE WITH AS 1725.1, FIGURE J1,
- 3. NOMINAL FENCE HEIGHT SHALL BE 1800mm (CHAIN LINK FABRIC
- 4. BACKSTAYS SHALL NOT BE USED.
- 5. ALL PIPE POSTS AND RAILS SHALL BE CLASS 1 (MEDIUM QUALITY) AS PER
- 6. JOINTS ONLY PERMITTED IN TOP RAIL AT NOT LESS THAN 6000mm
- 7. CHAIN LINK FABRIC SHALL BE: 50mm PITCH, 3.15mm WIRE, KNUCKLE-KNUCKLE (KK) SELVEDGE, BLACK FUSION BONDED COATED.
- 8. SUPPORT CABLE SHALL BE EITHER: a. BLACK FUSE-BONDED POLYMER-COATED HELICOIL CABLE WIRE IN ACCORDANCE WITH AS 1725.1 CLAUSE 3.8(c). b. BLACK FUSE-BONDED POLYMER-COATED TWIN-TWISTED CABLE WIRE
- IN ACCORDANCE WITH AS 1725.1 CLAUSE 3.8(f) .
- 9. LACING WIRE SHALL BE BLACK FUSE-BONDED POLYMER-COATED, IN ACCORDANCE WITH AS 1725.1 CLAUSE 3.9(c).
- 10. ALL STEEL ELEMENTS SHALL BE POWDER COATED BLACK, UNLESS NOTED
- 11. VARIATIONS TO THE DESIGN MUST BE VERIFIFIED BY A STRUCTURAL

Job Title
QUAIRADING SPORTS
PRECINCT - NETBALL COURTS

Drawing Title 1.8m HIGH FENCE DETAILS

Discipline		
FIELD OF PLAY		
Drawing Status		
FENDER		
Drawing Number		
SE_12234_F701		

Issue T1